
LANDSCAPE DEVELOPMENT

FOR WESTON TOWN GREEN 56 NORFIELD ROAD, WESTON

FEBRUARY 10, 2023

LOCATION MAP

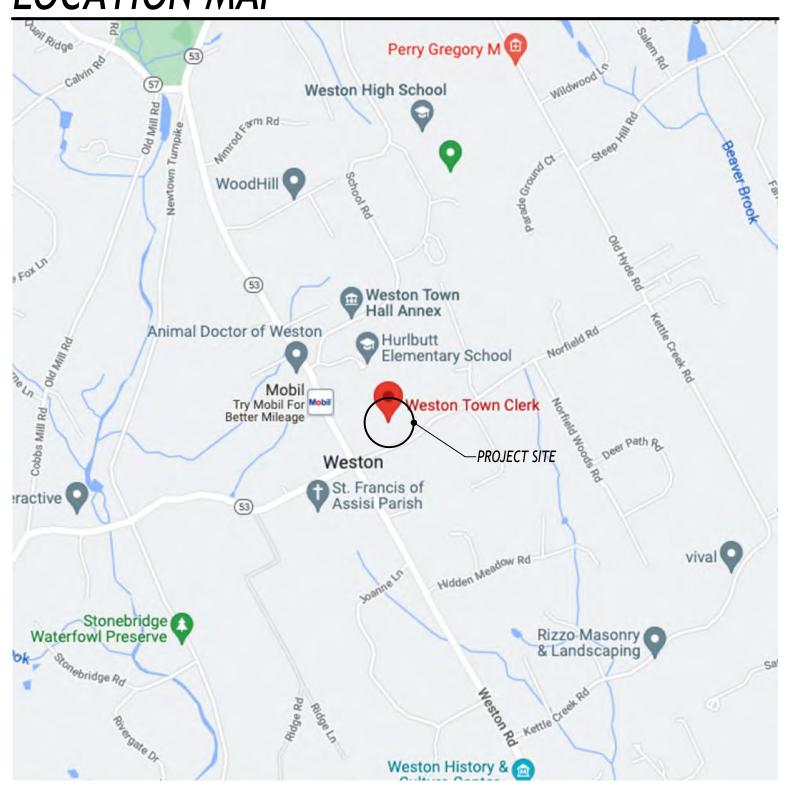

VICINITY MAP



LIST OF DRAWINGS

- T-1 TITLE SHEET
- G-1 GENERAL NOTES
- E-1 TOPOGRAPHIC SURVEY
- L-1 DEMO PLAN
- L-2 LAYOUT, MATERIALS, AND GRADING PLAN
- P-1 PLANTING PLAN
- P-2 PLANTING NOTES AND DETAILS
- D-1 DETAILS
- D-2 DETAILS
- D-3 DETAILS
- D-4 WAR MEMORIAL DETAILS
- E-0 ELECTRICAL SPECIFICATIONS
- E-1 ELECTRICAL SCHEDULES, NOTES, AND ABBREVIATIONS
- E-2 SITE ELECTRICAL PLAN

PROJECT DIRECTORY

TOWN OF WESTON

WESTON FIRST SELECT WOMAN

SAMANTHA NESTOR

TOWN ADMINISTRATOR

JONATHAN LUIZ

BEAUTIFICATION COMMITTEE CHAIR

CLAUDIA HAHN

LANDSCAPE ARCHITECT

WILLIAM KENNY ASSOCIATES LLC

DESIGN ARCHITECT

THIEL ARCHITECTURE + DESIGN

HORTICULTURE DESIGNER

KARIN'S GARDEN DESIGN

MEMORIAL DESIGNER

JULIE HANSELMANN DAVIES

SURVEYOR

STALKER LAND SURVEYING, INC.

ELECTRICAL ENGINEER

SG ENGINEERING

ABBREVIATIONS

(TYP.)	TYPICAL CONDITION	CONT.	CONTAINER
EQ.	EQUAL	B&B	BALL & BURLAPPED
EJ	EXPANSION JOINT	O.C	ON CENTER
CL	CENTER LINE	CAL.	TREE CALIPER
DIA.	DIAMETER	GAL.	PLANT CONTAINER
R	RADIUS	QUART	PLANT CONTAINER
MN.	MINIMUM	HT.	HEIGHT
MAX.	MAXIMUM	SPD	SPREAD
		QTY	QUANTITY

SUMMARY OF WORK

THE WORK SHALL BE AS SHOWN AND CALLED FOR IN THE CONTRACT DOCUMENTS AND SHALL INCLUDE, BUT NOT BE LIMITED TO, THE FOLLOWING GENERAL ITEMS OF WORK:

- 1. REMOVALS OF EXISTING PAVEMENTS AND MISCELLANEOUS ITEMS
- 2. SITE PREPARATION AND SEDIMENT AND EROSION CONTROLS CONSTRUCTION FENCING AND GRADING
- 3. INSTALLATION OF ELECTRICAL LIGHTING AND OUTLETS
- 4. INSTALLATION OF HARDSCAPE
- 5. INSTALLATION OF SITE FURNISHINGS
- 6. INSTALLATION OF PLANT MATERIAL

GENERAL NOTES

THE FOLLOWING NOTES SHALL APPLY THROUGHOUT. EXCEPTIONS ARE SPECIFICALLY NOTED ON EACH DRAWING.

- 1. THE CONTRACTOR SHALL FIELD VERIFY DIMENSIONS AND CONDITIONS OF THE SITE AND/OR BUILDING.
- 2. DRAWINGS ARE NOT TO BE SCALED. USE DIMENSIONS ONLY. DIMENSIONS AND CONDITIONS SHOWN AND ASSUMED ON THE DRAWINGS MUST BE VERIFIED AT THE SITE BY THE CONTRACTOR BEFORE ORDERING MATERIAL OR PERFORMING WORK. DISCREPANCIES IN THE DRAWINGS AND SPECIFICATIONS SHALL BE REPORTED TO THE LANDSCAPE ARCHITECT. CHANGES TO DRAWINGS OR SPECIFICATIONS IS NOT PERMISSIBLE WITHOUT THE WRITTEN CONSENT OF THE LANDSCAPE ARCHITECT. NO WORK SHALL PROCEED UNTIL SUCH DISCREPANCY HAS BEEN RECTIFIED.
- 3. WORK ON THESE DRAWINGS SHALL BE CONSIDERED NEW WORK WHETHER STATED OR NOT EXCEPT WHERE SPECIFICALLY NOTED AS "EXISTING TO REMAIN".
- 4. THE CONTRACTOR SHALL PERFORM CUTTING AND PATCHING REQUIRED TO COMPLETE THE WORK OR TO MAKE ITS PARTS FIT TOGETHER PROPERLY WITHOUT COMPROMISING THE QUALITY OF THE WORK.
- 5. COORDINATION OF WORK UNDER THIS CONTRACT SHALL BE MAINTAINED TO ENSURE THE QUALITY AND TIMELY COMPLETION OF THE WORK/PROJECT.
- 6. THE CONTRACTOR SHALL PATCH AND REPAIR DAMAGED OR EXPOSED SURFACES AND FENCES DUE TO CONTRACT WORK.
- 7. THE CONTRACTOR SHALL FURNISH AND INSTALL NEW MATERIALS AT NO ADDITIONAL COST TO THE TOWN OF WESTON FOR THE FOLLOWING CONDITIONS:
- A. EXISTING WORK THAT HAS BEEN REMOVED OR DAMAGED IN ORDER TO PERFORM THE CONTRACT WORK.
- B. TO FURNISH THE WORK OF THIS CONTRACT IN WORKMANLIKE MANNER.
- 8. THE CONTRACTOR SHALL BE RESPONSIBLE FOR ADEQUATELY BRACING AND PROTECTING WORK DURING CONSTRUCTION AGAINST DAMAGE, BREAKAGE, COLLAPSE, DISTORTIONS AND OFF ALIGNMENTS ACCORDING TO CODES AND STANDARDS OF GOOD PRACTICE.
- 9. THE CONTRACTOR SHALL INCLUDE PREPARATORY AND ASSOCIATED SUPPLEMENTARY WORK TO PROVIDE A COMPLETE AND FINISHED INSTALLATION.
- 10. WHERE MANUFACTURER'S NAMES AND PRODUCT NUMBERS ARE INDICATED ON DRAWINGS, IT SHALL BE CONSTRUED TO MEAN THE ESTABLISHMENT OF QUALITY AND PERFORMANCE STANDARDS OF SUCH ITEMS. PROPOSED SUBSTITUTIONS OF PRODUCTS MUST BE SUBMITTED TO THE LANDSCAPE ARCHITECT FOR APPROVAL BEFORE THEY SHALL BE DEEMED EQUAL.
- 11. SIZE OF MASONRY UNITS AND WOOD MEMBERS ON PLANS, ELEVATIONS AND SECTIONS ARE SHOWN AS NOMINAL SIZE.
- 12. DIMENSIONS ON PLANS ARE INDICATED FROM SURFACE TO SURFACE, EXCLUSIVE OF FINISHES.
- 13. PROVIDE GUARDS, RAILS, BARRICADES, FENCES, CATCH PLATFORMS, DECKING, NIGHT LIGHTING, ETC., AS REQUIRED BY THE TOWN OF WESTON BUILDING CODE AND AS REQUIRED TO PROVIDE ADEQUATE PROTECTION.
- 14. THE CONTRACTOR SHALL KEEP WORK SITE FREE FROM DEBRIS AND ACCUMULATED REFUSE, AND SHALL HAVE SOLE RESPONSIBILITY FOR PROTECTING DANGEROUS AREAS FROM ENTRY BY UNAUTHORIZED PARTIES. SITE SHALL BE LEFT BROOM CLEAN AT THE END OF EACH WORKING
- 15. THE CONTRACTOR SHALL, UNLESS OTHERWISE PROVIDED IN THE CONTRACT DOCUMENTS, SECURE AND PAY FOR REQUIRED INSPECTIONS, PERMIT(S), FEES, LICENSE AND INSPECTIONS NECESSARY FOR THE PROPER EXECUTION OF THE WORK.
- 16. THERE WILL BE NO CHANGE IN USE, EGRESS OR OCCUPANCY BECAUSE OF THE WORK OF THIS CONTRACT.
- 17. ADDITIONAL NOTES WHICH ARE APPLICABLE TO THIS PROJECT MAY BE FOUND THROUGHOUT THE CONTRACT DOCUMENTS.
- 18. THE CONTRACTOR WILL BE PROVIDED WITH ELECTRONIC TOPOGRAPHIC SURVEY AND CONSTRUCTION PLANS FOR DEVELOPMENT OF A CERTIFIED HORIZONTAL CONTROL PLAN TO BE PREPARED BY LAND SURVEYOR AND SUBMITTED TO THE RESIDENT LANDSCAPE ARCHITECT FOR REVIEW AND APPROVAL PRIOR TO CONSTRUCTION. CONTRACTOR SHALL PROVIDE CONSTRUCTION STAKING THROUGHOUT THE DURATION OF THE PROJECT IN COMPLIANCE WITH THE PLANS AND CERTIFIED HORIZONTAL CONTROL PLAN.

SURVEY NOTES

THE SURVEY IS BASED ON THE TOWN OF WESTON SUPPLIED SURVEY PERFORMED BY STALKER LAND SURVEYING INC. AND DATED 8/31/22 SUPPLEMENTED WITH AS BUILT DRAWINGS PROVIDED BY THE TOWN OF WESTON.

- 1. THE SURVEY IS FOR REFERENCE ONLY.
- 2. LOCATIONS, EXTENT AND SIZES OF UNDERGROUND UTILITIES AND SUBSTRUCTURES HAVE BEEN DETERMINED FROM RECORD INFORMATION, SUPPLEMENTED BY DATA OBTAINED IN THE FIELD. ACCURACY OF THIS UTILITY DATA IS NOT GUARANTEED, NOR IS THERE ANY GUARANTEE THAT ALL EXISTING UTILITIES AND SUBSTRUCTURES, WHETHER FUNCTIONAL OR ABANDONED, ARE SHOWN ON THIS MAP. VERIFICATION OF SIZE OF PIPE, DIRECTION OF FLOW, PIPE INVERT AND LOCATION IS MANDATORY BEFORE THE START OF CONSTRUCTION.
- 3. INFORMATION ON THE SURVEY THAT PERTAINS TO THE PROPERTY LINE IS FOR REFERENCE ONLY.
- 4. "ONLY COPIES FROM THE ORIGINAL OF THIS SURVEY MARKED WITH AN ORIGINAL OF THE LAND SURVEYOR'S BLUE INKED OR EMBOSSED SEAL SHALL BE CONSIDERED TO BE A TRUE VALID COPY".
- 5. "UNAUTHORIZED ALTERATIONS OR ADDITION TO A LAND SURVEYING DRAWING BEARING A LICENSED PROFESSIONAL LAND SURVEYOR'S SEAL IS A VIOLATION OF CONNECTICUT STATE LAW.

 6. CONSULT WITH TOWN OF WESTON PARKS AND RECREATION BEFORE DESIGNING, INSTALLING OR
- 6. CONSULT WITH TOWN OF WESTON PARKS AND RECREATION BEFORE DESIGNING, INSTALLING OR MODIFYING NEW OR EXISTING CURBS, WALKS OR ROADWAYS IN THE STREETS SHOWN HEREON.
- 7. SUBSURFACE INFORMATION SHOWN HEREON WAS OBTAINED FROM VARIOUS TOWN DEPARTMENTS AND/OR PRIVATE UTILITY COMPANIES. THE SUPPLIER OF THE SURVEYOR DOES NOT CERTIFY AS TO THE ACCURACY OR COMPLETENESS OF THIS DATA AND USERS OF THIS SURVEY AGREE TO HOLD THE TOWN SURVEYOR HARMLESS FOR SAME. THE LOCATION OF SAID UTILITIES SHOULD BE CONSIDERED APPROXIMATE AND MUST BE CONFIRMED BY THE USER OF THIS SURVEY PRIOR TO CONSTRUCTION.
- 8. NO SUBSURFACE UTILITY INFORMATION WITHIN THE PROPERTY IS SHOWN. CONTACT "CALL BEFORE YOU DIG 811" TO HAVE ALL SUBSURFACE UTILITY INFORMATION WITHIN THE PROPERTY MARKED OUT PRIOR TO CONSTRUCTION. THE SUPPLIER OF THE SURVEYOR WILL NOT BE LIABLE OR HELD RESPONSIBLE FOR DAMAGES TO SUBSURFACE UTILITIES EITHER WITHIN OR OUTSIDE THE SURVEYED PROPERTY DUE TO CONSTRUCTION.

SURVEY NOTES

- 8. SURVEYED PROPERTY DUE TO CONSTRUCTION.
- 9. THE USER OF THE SURVEY EXPRESSLY UNDERSTANDS AND AGREES THAT THE SURVEYOR MAKES NO CLAIM AND DOES NOT GUARANTEE THAT THE UTILITIES SHOWN HEREON ARE PUBLIC OR THAT ANY PROPERTIES SHOWN ON THIS SURVEY WILL BE ABLE TO CONNECT TO SAME.
- 10. THE OFFSETS OR DIMENSIONS SHOWN FROM THE STRUCTURES TO THE PROPERTY LINES ARE FOR A SPECIFIC PURPOSE AND USE AND THEREFORE ARE NOT INTENDED TO GUIDE THE ERECTION OF SITE IMPROVEMENTS AND OTHER CONSTRUCTION.
- 11. THE EXISTENCE OF RIGHT OF WAYS AND/OR EASEMENTS OF RECORD, IF ANY, NOT SHOWN ARE NOT CERTIFIED.
- 12. WILLIAM KENNY ASSOCIATES LLC TAKES NO RESPONSIBILITY FOR THE ACCURACY OF THE SURVEY.

SITE ACCESS & STAGING

- 1. IT IS THE CONTRACTOR'S RESPONSIBILITY TO MAINTAIN UNIMPEDED FIRE EGRESS ROUTES IN ACCORDANCE WITH APPLICABLE TOWN CODES.
- 2. CONTRACTOR SHALL CONFIRM PEDESTRIAN AND VEHICULAR CIRCULATION REQUIREMENTS WITH THE TOWN PARKS AND RECREATION DIRECTOR ADMINISTRATIVE STAFF PRIOR TO CONSTRUCTION.
- 3. CONTRACTOR SHALL BE RESPONSIBLE FOR PROVIDING TEMPORARY FENCE AND GATE WORK, AS WELL AS WORK RELATING TO ALTERATIONS TO EXISTING FENCING FOR ACCESS AND STAGING PURPOSES. CONTRACTOR SHALL BE RESPONSIBLE FOR RESTORING FENCING AND GATES TO ORIGINAL CONDITION AFTER COMPLETION OF CONSTRUCTION ACTIVITIES.
- 4. REFER TO SPECIFICATION SECTIONS 01300 PROJECT CONDITIONS AND 02100 SITE PREPERATION.

SITE SAFETY & PROTECTION NOTES

- 1. CONTRACTOR SHALL SUBMIT TO THE LANDSCAPE ARCHITECT FOR REVIEW A SITE SAFETY PLAN(S). THE PLAN(S) SHALL BE COMPLETE, REFLECTING THE ENTIRE SITE AND SHALL SHOW ANY PHASED PROTECTION.
- 2. THE SITE SAFETY PLAN(S) SHALL INCLUDE, BUT SHALL NOT BE LIMITED TO, NOTES, FENCES, EGRESS, SCAFFOLDING, FIRE PROTECTION ETC. THEY SHOULD ADDRESS POTENTIAL INTERACTION BETWEEN THE GENERAL PUBLIC AND EXPOSURE TO THE CONSTRUCTION PROCESS.
- 3. SEE SPECIFICATION 01300 FOR TEMPORARY FACILITIES AND CONTROLS DETAILS.
- 4. NO WORK IS TO PROCEED UNTIL SITE SAFETY PLANS ARE APPROVED BY THE LANDSCAPE ARCHITECT.

GRADING NOTES:

- 1. DISCREPANCIES BETWEEN ACTUAL FIELD CONDITIONS AND THOSE SHOWN ON THE PLANS ARE TO BE BROUGHT TO THE IMMEDIATE ATTENTION OF THE LANDSCAPE ARCHITECT. WORK SHALL NOT PROCEED UNTIL THE DISCREPANCY IS RESOLVED AND WRITTEN APPROVAL FROM BOTH THE OWNER AND LANDSCAPE ARCHITECT IS OBTAINED.
- 2. MODIFICATIONS TO THE PROPOSED GRADING AS SHOWN ON THESE PLANS MUST BE APPROVED, IN WRITING, BY THE LANDSCAPE ARCHITECT.
- 3. LOCATION OF EXISTING DRAINAGE STRUCTURES AND PIPES ARE APPROXIMATE. THE CONTRACTOR SHALL FIELD-VERIFY LOCATIONS AND NOTIFY THE LANDSCAPE ARCHITECT OF DISCREPANCIES.
- 4. NEW PAVEMENTS SHALL MEET EXISTING PAVEMENTS TO REMAIN FLUSH WITHOUT LEAVING AREAS WHERE WATER CAN PUDDLE OR BECOME TRAPPED.
- 5. CURBS SHALL BE FLUSH WITH SURROUNDING PAVEMENT UNLESS OTHERWISE NOTED.
- NEW PAVEMENTS SHALL BE CONSTRUCTED TO THE GRADES SHOWN ON THE PLANS AND SO THAT THEY DO NOT CREATE PONDING OF WATER.
- 7. SPOT ELEVATIONS ON GRADING PLAN SHALL BE MET GRADUALLY AND ARE SUBJECT TO THE LANDSCAPE ARCHITECT'S APPROVAL.
- 8. THE USER OF THESE DRAWINGS IS CAUTIONED THAT THE UNDERGROUND UTILITY LOCATIONS ARE NOT GUARANTEED, NOR IS THERE A GUARANTEE THAT EXISTING UTILITIES, WHETHER FUNCTIONAL OR ABANDONED, WITHIN THE PROJECT ARE SHOWN ON THESE DRAWINGS. PRIOR TO ANY WORK CALL "CALL BEFORE YOU DIG" 811.

CONCRETE NOTES

- A. GENERAL VERIFY FIEL
- VERIFY FIELD DIMENSIONS BY MEASUREMENT AT THE JOB SITE BEFORE SUBMITTING SHOP DRAWINGS.
- B. CONCRETE DESIGN
 - 1. DESIGN OF REINFORCED CONCRETE MEMBERS IS IN ACCORDANCE WITH THE PROVISIONS OF THE SPECIFICATIONS SECTION 033000 AND SECTION 321316.
 - 2. CONCRETE WORK MIXES, INSPECTIONS, AND FORMWORK SHALL CONFORM TO THE REQUIREMENTS OF THE SPECIFICATIONS SECTION 033000.
 - 3. PROPORTION, BATCH, AND MIX CONCRETE IN ACCORDANCE WITH <u>SECTION 03300.</u>
 PROPORTION CONCRETE MIX IN ACCORDANCE WITH <u>SECTION 033000</u>. MIXES SHALL HAVE
 - INCLUDED ADMIXTURES THAT WILL BE USED DURING THIS CONSTRUCTION.

 4. THE METHOD FOR CONVEYING CONCRETE TO THE PLACE OF DEPOSIT SHALL COMPLY WITH SECTION 033000.

PLANTING NOTES:

- 1. DISCREPANCIES BETWEEN ACTUAL FIELD CONDITIONS AND THOSE SHOWN ON THE PLANS ARE TO BE BROUGHT TO THE IMMEDIATE ATTENTION OF THE LANDSCAPE ARCHITECT. WORK SHALL NOT PROCEED UNTIL THE DISCREPANCY IS RESOLVED AND WRITTEN APPROVAL FROM THE LANDSCAPE ARCHITECT IS OBTAINED.
- NOTIFY THE LANDSCAPE ARCHITECT, IN WRITING, OF DRAINAGE CONDITIONS DETRIMENTAL TO THE GROWTH OF PLANTS, PRIOR TO PLANTING.
 PLANTS SHALL BE FRESHLY DUG; NEITHER HEELED-IN PLANTS NOR PLANTS FROM COLD STORAGE
- WILL BE ACCEPTED.

 4. PLANT SIZES SPECIFIED ARE TO BE CONSIDERED MINIMUM. CONTRACTOR SHALL NOTIFY THE
- 4. PLANT SIZES SPECIFIED ARE TO BE CONSIDERED MINIMUM. CONTRACTOR SHALL NOTIFY THE LANDSCAPE ARCHITECT OF DISCREPANCIES.
 5. PLANTS SHALL BE SUBJECT TO INSPECTION AND APPROVAL BY THE LANDSCAPE ARCHITECT. THE
- LANDSCAPE ARCHITECT RESERVES THE RIGHT TO REJECT UNACCEPTABLE PLANT MATERIAL ON OR AFTER DELIVERY TO THE SITE.

 6. TOPSOIL SHALL BE FREE OF SOIL-BORNE DISEASE AND PESTS, AS WELL AS WEED SEEDS.

 7. PLANTING SHALL BE MULCHED WITH SHREDDED HARDWOOD MULCH IMMEDIATELY AFTER PLANTING. MULCH SHALL BE FREE OF INJURIOUS SUBSTANCE AND DEBRIS. MULCH SHALL BE
- LANDSCAPE ARCHITECT.

 8. PLANTS SHALL BE IN ACCORDANCE WITH ANSI Z60.1 (LATEST ADDITION) FOR THE SIZES AND SPECIES INDICATED.

LIFE OF THE PROJECT AND PRIOR TO HAND-OVER OF SITE TO CLIENT TO SATISFACTION OF

SPREAD TO THE DEPTHS INDICATED ON THE DRAWINGS. MULCH SHALL BE REPLENISHED OVER THE

MATERIALS NOTES

- 1. SEE SPECIFICATIONS.
- 2. BEFORE COMMENCING CONSTRUCTION, PHOTOGRAPH EXISTING SITE CONDITIONS, INCLUDING, BUT NOT LIMITED TO GATES, FENCES, CURBS, DRAINAGE STRUCTURES, WALLS, BUILDING FACADES, THRESHOLDS, AND PLANT MATERIAL. EXISTING SITE ELEMENTS TO REMAIN SHALL BE RETURNED TO FOUND CONDITION AT CONTRACTOR'S EXPENSE.
- 3. BEFORE COMMENCING CONSTRUCTION, CONTRACTOR SHALL FIELD VERIFY EXISTING ELEVATIONS AND SITE CONDITIONS.
- 4. SEE PLAN SHEETS FOR ADDITIONAL NOTES.

DEMOLITION NOTES:

- 1. EXISTING OR BELOW GRADE ELEMENTS THAT ARE NOT INDICATED ON THE DRAWINGS WHICH POTENTIALLY CONFLICT WITH DEMOLITION WORK SHALL IMMEDIATELY BE BROUGHT TO THE LANDSCAPE ARCHITECT'S ATTENTION BEFORE PROCEEDING FURTHER.
- 2. NO DANGEROUS CONDITIONS SHALL BE LEFT WITHOUT APPROPRIATE BARRIERS, HAZARD
- WARNINGS OR INDICATORS IN FULL COMPLIANCE WITH GOVERNING CODES AND REGULATIONS.

 3. PAVEMENT, CURBS, WALLS, EXISTING STRUCTURES, OR PLANT MATERIAL NOT INDICATED FOR REMOVAL SHALL BE FULLY PROTECTED FROM DAMAGE DURING THE DEMOLITION PROCESS.

 DAMAGE OCCURRING AS A RESULT OF NEGLIGENCE IN NOT FOLLOWING PROPER PROCEDURES SHALL BE REPAIRED AT THE CONTRACTOR'S EXPENSE.
- 4. UNDERGROUND PIPES SHALL BE PROTECTED FROM WEIGHT OF CONSTRUCTION VEHICLES AND EQUIPMENT ONCE PAVEMENT IS REMOVED.
- 5. HAND EXCAVATION SHALL BE USED WHEN EXCAVATING OR TRENCHING WITHIN DRIPLINE OF EXISTING TREES IN ORDER TO AVOID ROOT DAMAGE. HAND EXCAVATION SHALL BE DONE WITH EXTREME CARE AND WITH MINIMAL IMPACT ON SURROUNDING TREES. WHEN ROOTS LARGER THAN 1 INCH DIAMETER ARE ENCOUNTERED WHEN EXCAVATING, THE CONDITION SHALL BE BROUGHT TO THE ATTENTION OF THE LANDSCAPE ARCHITECT. ROOTS TO BE CUT SHALL BE CUT CLEANLY, AND PERPENDICULAR TO ROOT GROWTH. EXPOSED ROOTS SHALL BE KEPT MOIST WITH BURLAP COVERING UNTIL SOIL IS REPLACED. NO VEHICLES SHALL PARK OR DRIVE BENEATH THE DRIP LINE OF TREES. MATERIAL STORAGE AND STOCKPILING OF DEBRIS BENEATH THE DRIP LINE OF TREES IS PROHIBITED. IF VEHICLES MUST DRIVE BENEATH THE DRIP LINE OF TREES, A 6 INCH LAYER OF WOOD CHIPS SHALL BE PLACED AND MAINTAINED BY THE CONTRACTOR AT THE CONTRACTOR'S EXPENSE TO PROTECT THE ROOT ZONE.

CONSTRUCTION SCHEDULE:

THE CONTRACTOR SHALL BE REQUIRED TO PROVIDE AN EMAIL CONSTRUCTION SCHEDULE OF WORK THAT IS ANTICIPATED FOR THE FOLLOWING TWO WEEKS BY 3 PM EVERY FRIDAY TO THE LANDSCAPE ARCHITECT.

WILLIAM KENNY ASSOCIATES

LANDSCAPE ARCHITECTURE = ECOLOGICAL SERVICES

1899 Bronson Road Fairfield CT 06824

1899 Bronson Road Fairfield CT 06824 203 366 0588 www.wkassociates.net

PROJECT:

WESTON TOWN GREEN

OWNER / CLIENT:

WESTON BEAUTIFICATION COMMITTEE

56 NORFIELD ROAD WESTON, CT

DESIGN ARCHITECT:

THIEL ARCHITECTURE + DESIGN

1480 POST ROAD EAST 5A WESTPORT, CT

HORTICULTURAL DESIGNER:

KARIN'S GARDEN DESIGN

14 STONEHENGE ROAD WESTON, CT

MEMORIAL DESIGNER:

JULIE HANSELMANN DAVIES

57 PARK TERRACE EAST B27 NEW YORK, NY

ELECTRICAL ENGINEER:

SG ENGINEERING

56 FOXCROFT COURT SOUTHINGTON, CT

PROGRESS ISSUE:

ISSUED FOR BID

02/10/2023

KEY PLAN:

SCALE:

SEAL:

SHEET TITLE:

GENERAL NOTES

SHEET NUMBER:

G- '

NOTES:

ANY REPRODUCTION, ALTERATION, OR REPRINTING WITHOUT THE SURVEYOR'S KNOWLEDGE AND APPROVAL, WILL VOID ANY CERTIFICATIONS, AND NO LIABILITY SHALL BE ASSUMED BY THE SURVEYOR FOR THE SAME.

THIS MAP NOT VALID WITHOUT THE SURVEYOR'S LIVE SIGNATURE AND EMBOSSED SEAL.

NOT ALL UNDERGROUND UTILITIES, STRUCTURES, AND FACILITIES NOT FIELD LOCATED. THE SIZE, LOCATION, EXISTENCE OR NON—EXISTENCE OF ALL SUCH FEATURES MUST BE FIELD DETERMINED AND VERIFIED BY THE APPROPRIATE AUTHORITIES. CONTACT "CALL BEFORE YOU DIG" AT 1—800—922—4455.

REFERENCE MADE TO SKETCH MAP DRAWN BY CHUCK RUGGIERO, AND PROVIDED TO THIS OFFICE, SHOWING THE APPROXIMATE LOCATION OF UNDERGROUND UTILITIES MARKED ON SITE WITH FLAGGING AND PAINT, WHICH WERE FIELD LOCATED BY THIS OFFICE 8/31/22. NO RESPONSIBILITY ACCEPTED BY THIS OFFICE FOR THE ACCURACY OF THE MARKINGS, OR THE OMISSION OF ANY PERTINENT DATA.

REFERENCE MADE TO SKETCH MAP PREPARED BY SO. CONN. GAS CO., JOB # S60607, DATED 9/9/96, SHOWING THE APPROXIMATE LOCATION OF AN UNDERGROUND GAS MAIN NOT FLAGGED IN THE FIELD.

REFERENCE MADE TO SKETCH MAP PREPARED BY SO. CONN. GAS CO., TITLED "SCHOOL RD., WESTON, MAIN ON PRIV. PROP., TOWN HALL COMPLEX" SHOWING THE APPROXIMATE LOCATION OF AN UNDERGROUND GAS MAIN NOT FLAGGED IN THE FIELD.

ENCROACHMENTS, IF ANY, NOT LOCATED FOR THE PURPOSE OF THIS SURVEY.

THE PURPOSE OF THIS SURVEY IS TO SHOW TOPOGRAPHIC FEATURES.

DATUM: NAVD88 (COMPUTED USING GEOID18 VIA NGS OPUS-RS SOLUTION)
CONTOUR INTERVAL: 1 FOOT.

LEGEND

LIGHT POLE

MANHOLE

ELECTRICAL CONNECTION BOX

FLAGGED UNDERGROUND ELECTRIC LINE

FLAGGED UNDERGROUND GAS LINE

FLAGGED UNDERGROUND GAS LINE

GGGG

FLAGGED UNDERGROUND COMMUNICATION LINE


CONTOUR - MAJOR

CONTOUR - MINOR

SPOT ELEVATION

EDGE OF PAVEMENT

PLANTING BED

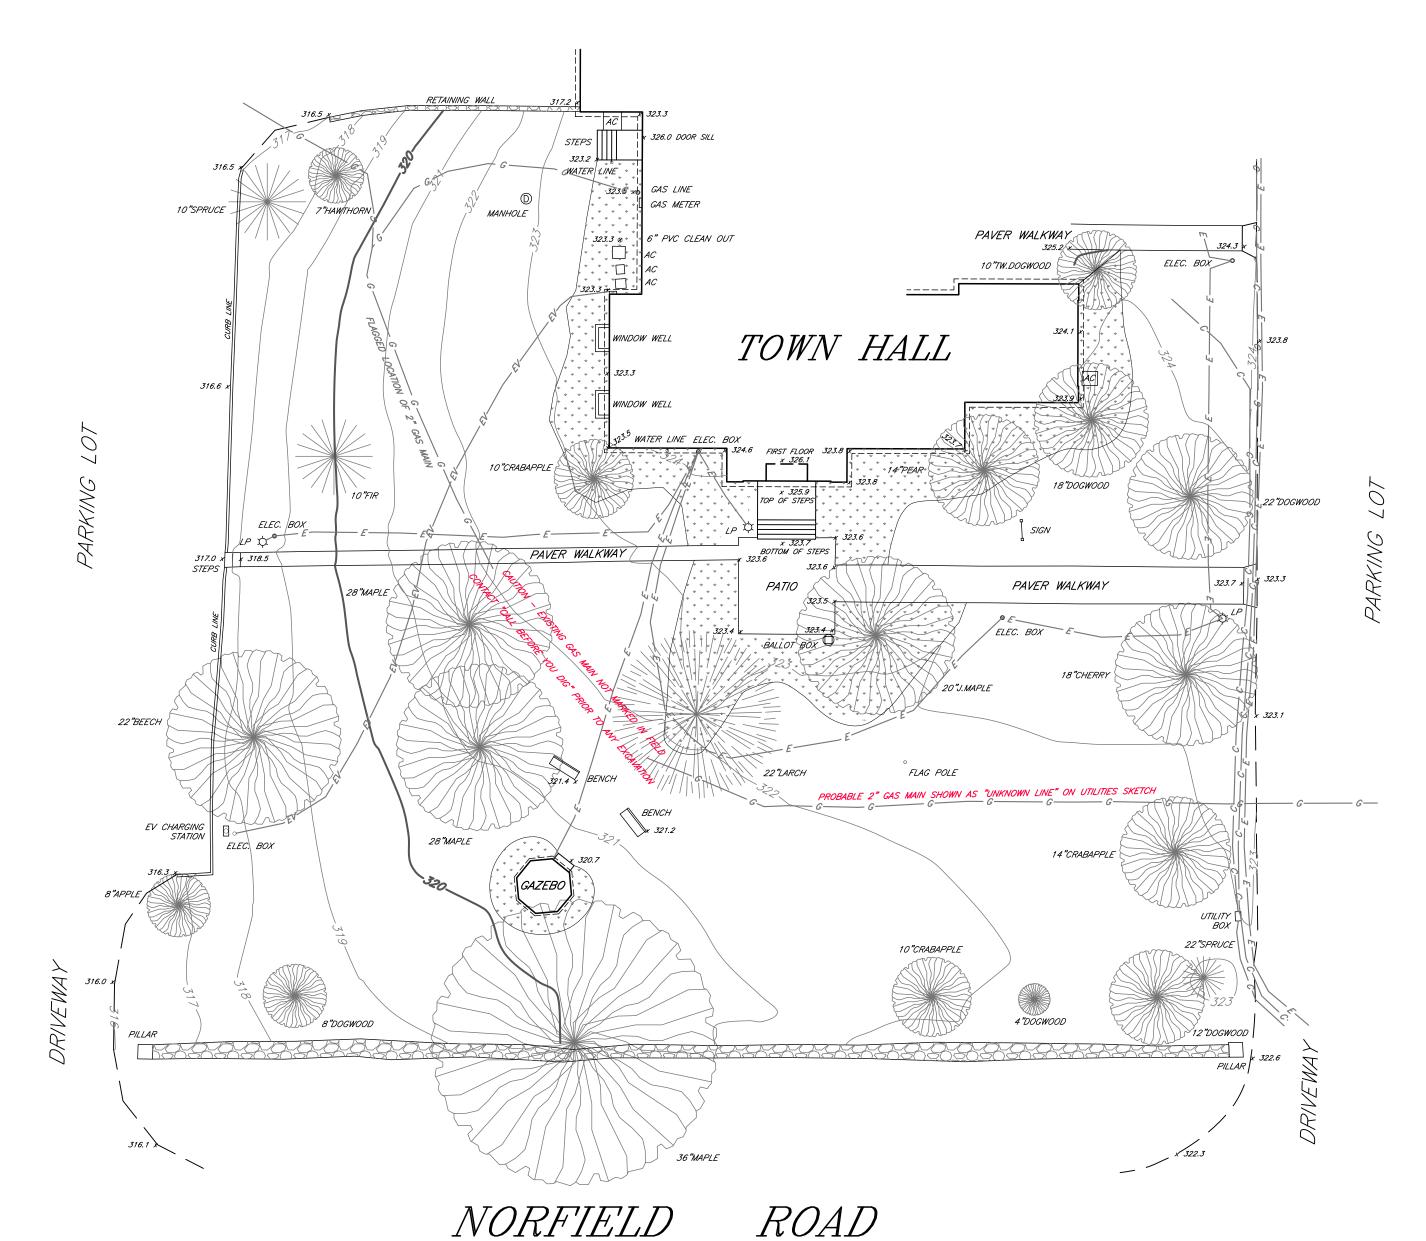

THIS MAP HAS BEEN PREPARED PURSUANT TO THE REGULATIONS OF CONNECTICUT STATE AGENCIES SECTION 20-300B-1 THROUGH 20-300B-20 AND THE "STANDARDS FOR SURVEYS AND MAPS IN THE STATE OF CONNECTICUT" AS ADOPTED BY THE CONNECTICUT ASSOCIATION OF LAND SURVEYORS, INC. ON SEPTEMBER 26, 1996, AMENDED OCTOBER 26, 2018.

SURVEY TYPE: TOPOGRAPHIC LOCATION SURVEY
BOUNDARY DETERMINATION CATEGORY: RESURVEY
CLASS OF ACCURACY: T-2

TO MY KNOWLEDGE AND BELIEF, THIS MAP IS SUBSTANTIALLY CORRECT AS NOTED HEREON. CERTIFIED BY:

POGER A. STALKER, LS # 70009 PDF COPY


TOPOGRAPHIC SURVEY
56 NORFIELD ROAD

ZONE: C
WESTON, CONNECTICUT

PREPARED FOR

TOWN OF WESTON

AUGUST 31, 2022

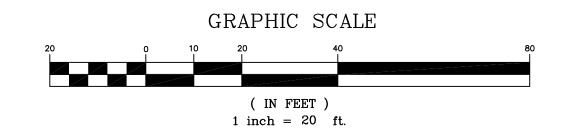


STA				
	RAS	+ EV CHARGER & 2" GAS MAIN	11-30-22	1
/ \	BY	DESCRIPTION	DATE	NO.

327.6 TOP OF HYDRANT

STALKER LAND SURVEYING, INC.
Roger Stalker, LS 503 Danbury Road Wilton, Connecticut 06897
TEL (203) 563-0048

	DRAWN BY:	RAS	DATE:	8	-31-	-22	
	CHECKED BY:	RAS	DRAWING	NO.: 5	56 N	ORFIEL	D
1/	JOB NO.:	08312022	SHEET	1	OF	1	

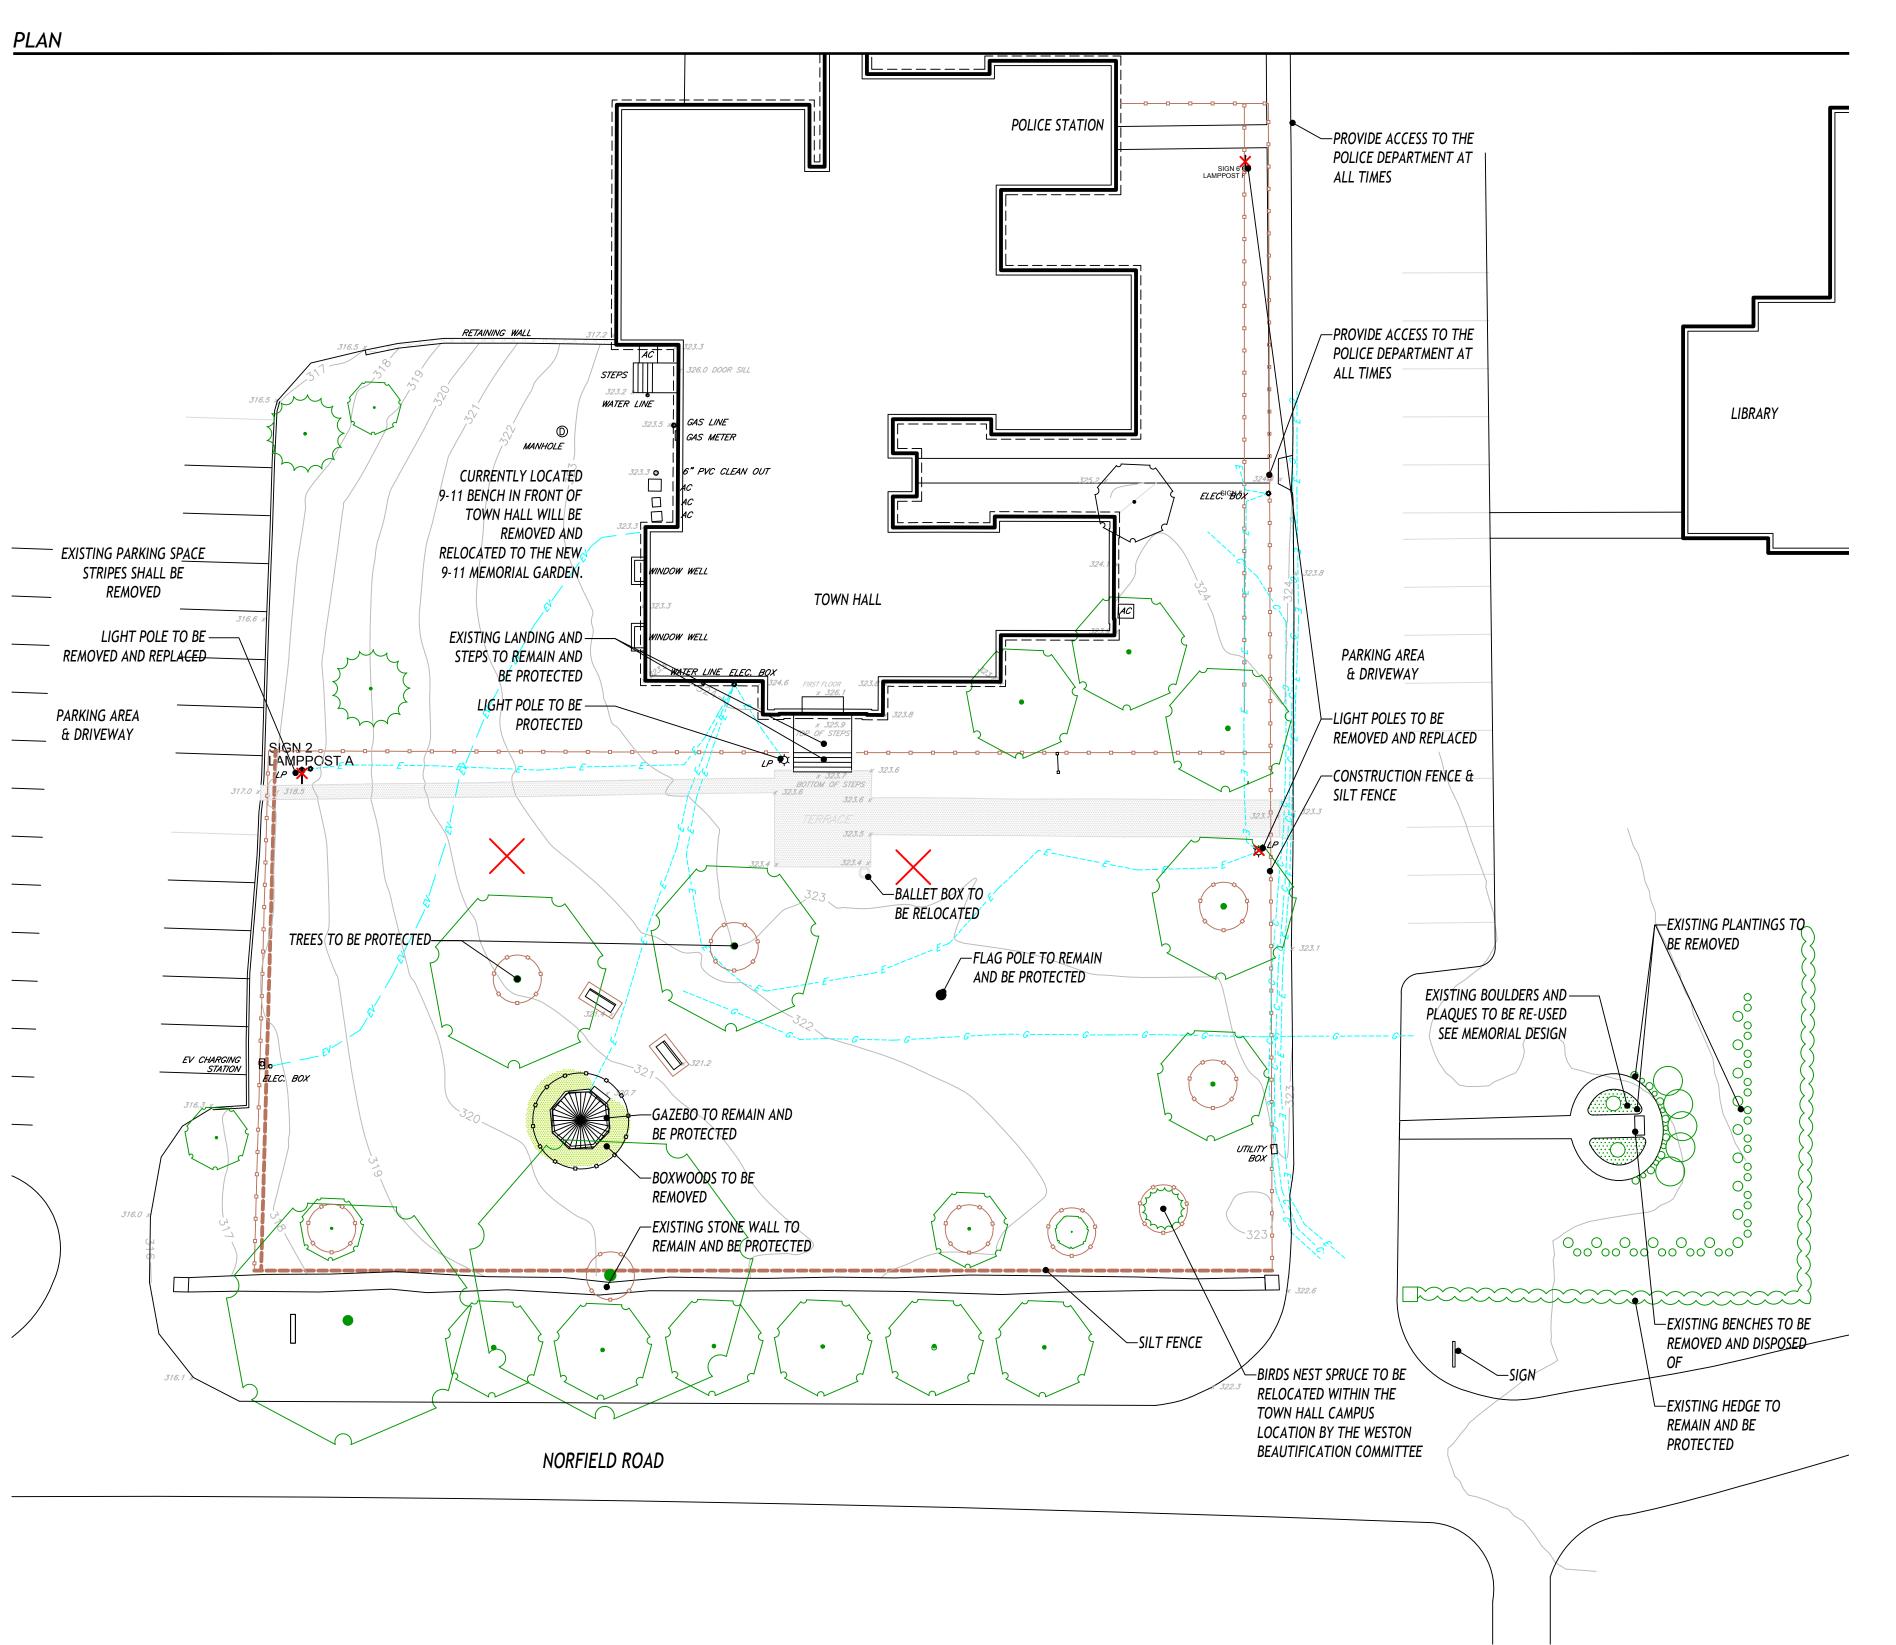

GENERAL NOTES


- 1. MATERIALS SCHEDULED FOR REMOVAL SHALL BE DISPOSED OF IN A LEAGUE MANOR
- 2. IF IN THE PROCESS OF SITE PREPARATION THE CONTRACTOR UNCOVERS LARGE STONES OR BOULDERS, THE TOWN OF WESTON RESERVES THE RIGHT TO USE THEM ON SITE AT NO ADDITIONAL COST.

LEGEND

EXISTING CONTOUR
EXISTING SPOT GRADE

EXISTING WALL TO REMAIN AND BE PROTECTED


EXISTING UTILITY

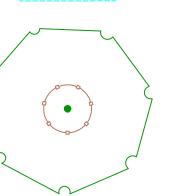


EXISTING TREE TO REMAIN & BE PROTECTED SEE TREE PROTECTION DETAIL ON SHEET ***



EXISTING TREE STUMP TO BE REMOVED

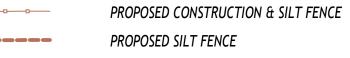

EXISTING CONCRETE WALK & TERRACE TO BE REMOVED

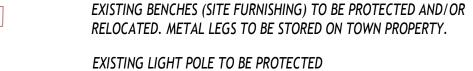

EXISTING LIGHT POLE TO BE REMOVED

WILLIAM KENNY ASSOCIATES

203 366 0588 www.wkassociates.net

LANDSCAPE ARCHITECTURE

ECOLOGICAL SERVICES

1899 Bronson Road Fairfield CT 06824

WESTON TOWN GREEN

OWNER / CLIENT:

PROJECT:

WESTON BEAUTIFICATION COMMITTEE

56 NORFIELD ROAD WESTON, CT

DESIGN ARCHITECT:

THIEL ARCHITECTURE + DESIGN

1480 POST ROAD EAST 5A WESTPORT, CT

HORTICULTURAL DESIGNER:

KARIN'S GARDEN DESIGN

14 STONEHENGE ROAD WESTON, CT

MEMORIAL DESIGNER:

JULIE HANSELMANN DAVIES

57 PARK TERRACE EAST B27 NEW YORK, NY

ELECTRICAL ENGINEER:

SG ENGINEERING

56 FOXCROFT COURT SOUTHINGTON, CT

PROGRESS ISSUE:


1 ISSUED FOR BID

02/10/2023

KEY PLAN:

SCALE: |0' |10' |20'

SEAL:

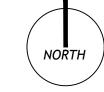


SHEET TITLE:

DEMO PLAN

SHEET NUMBER:

L-1

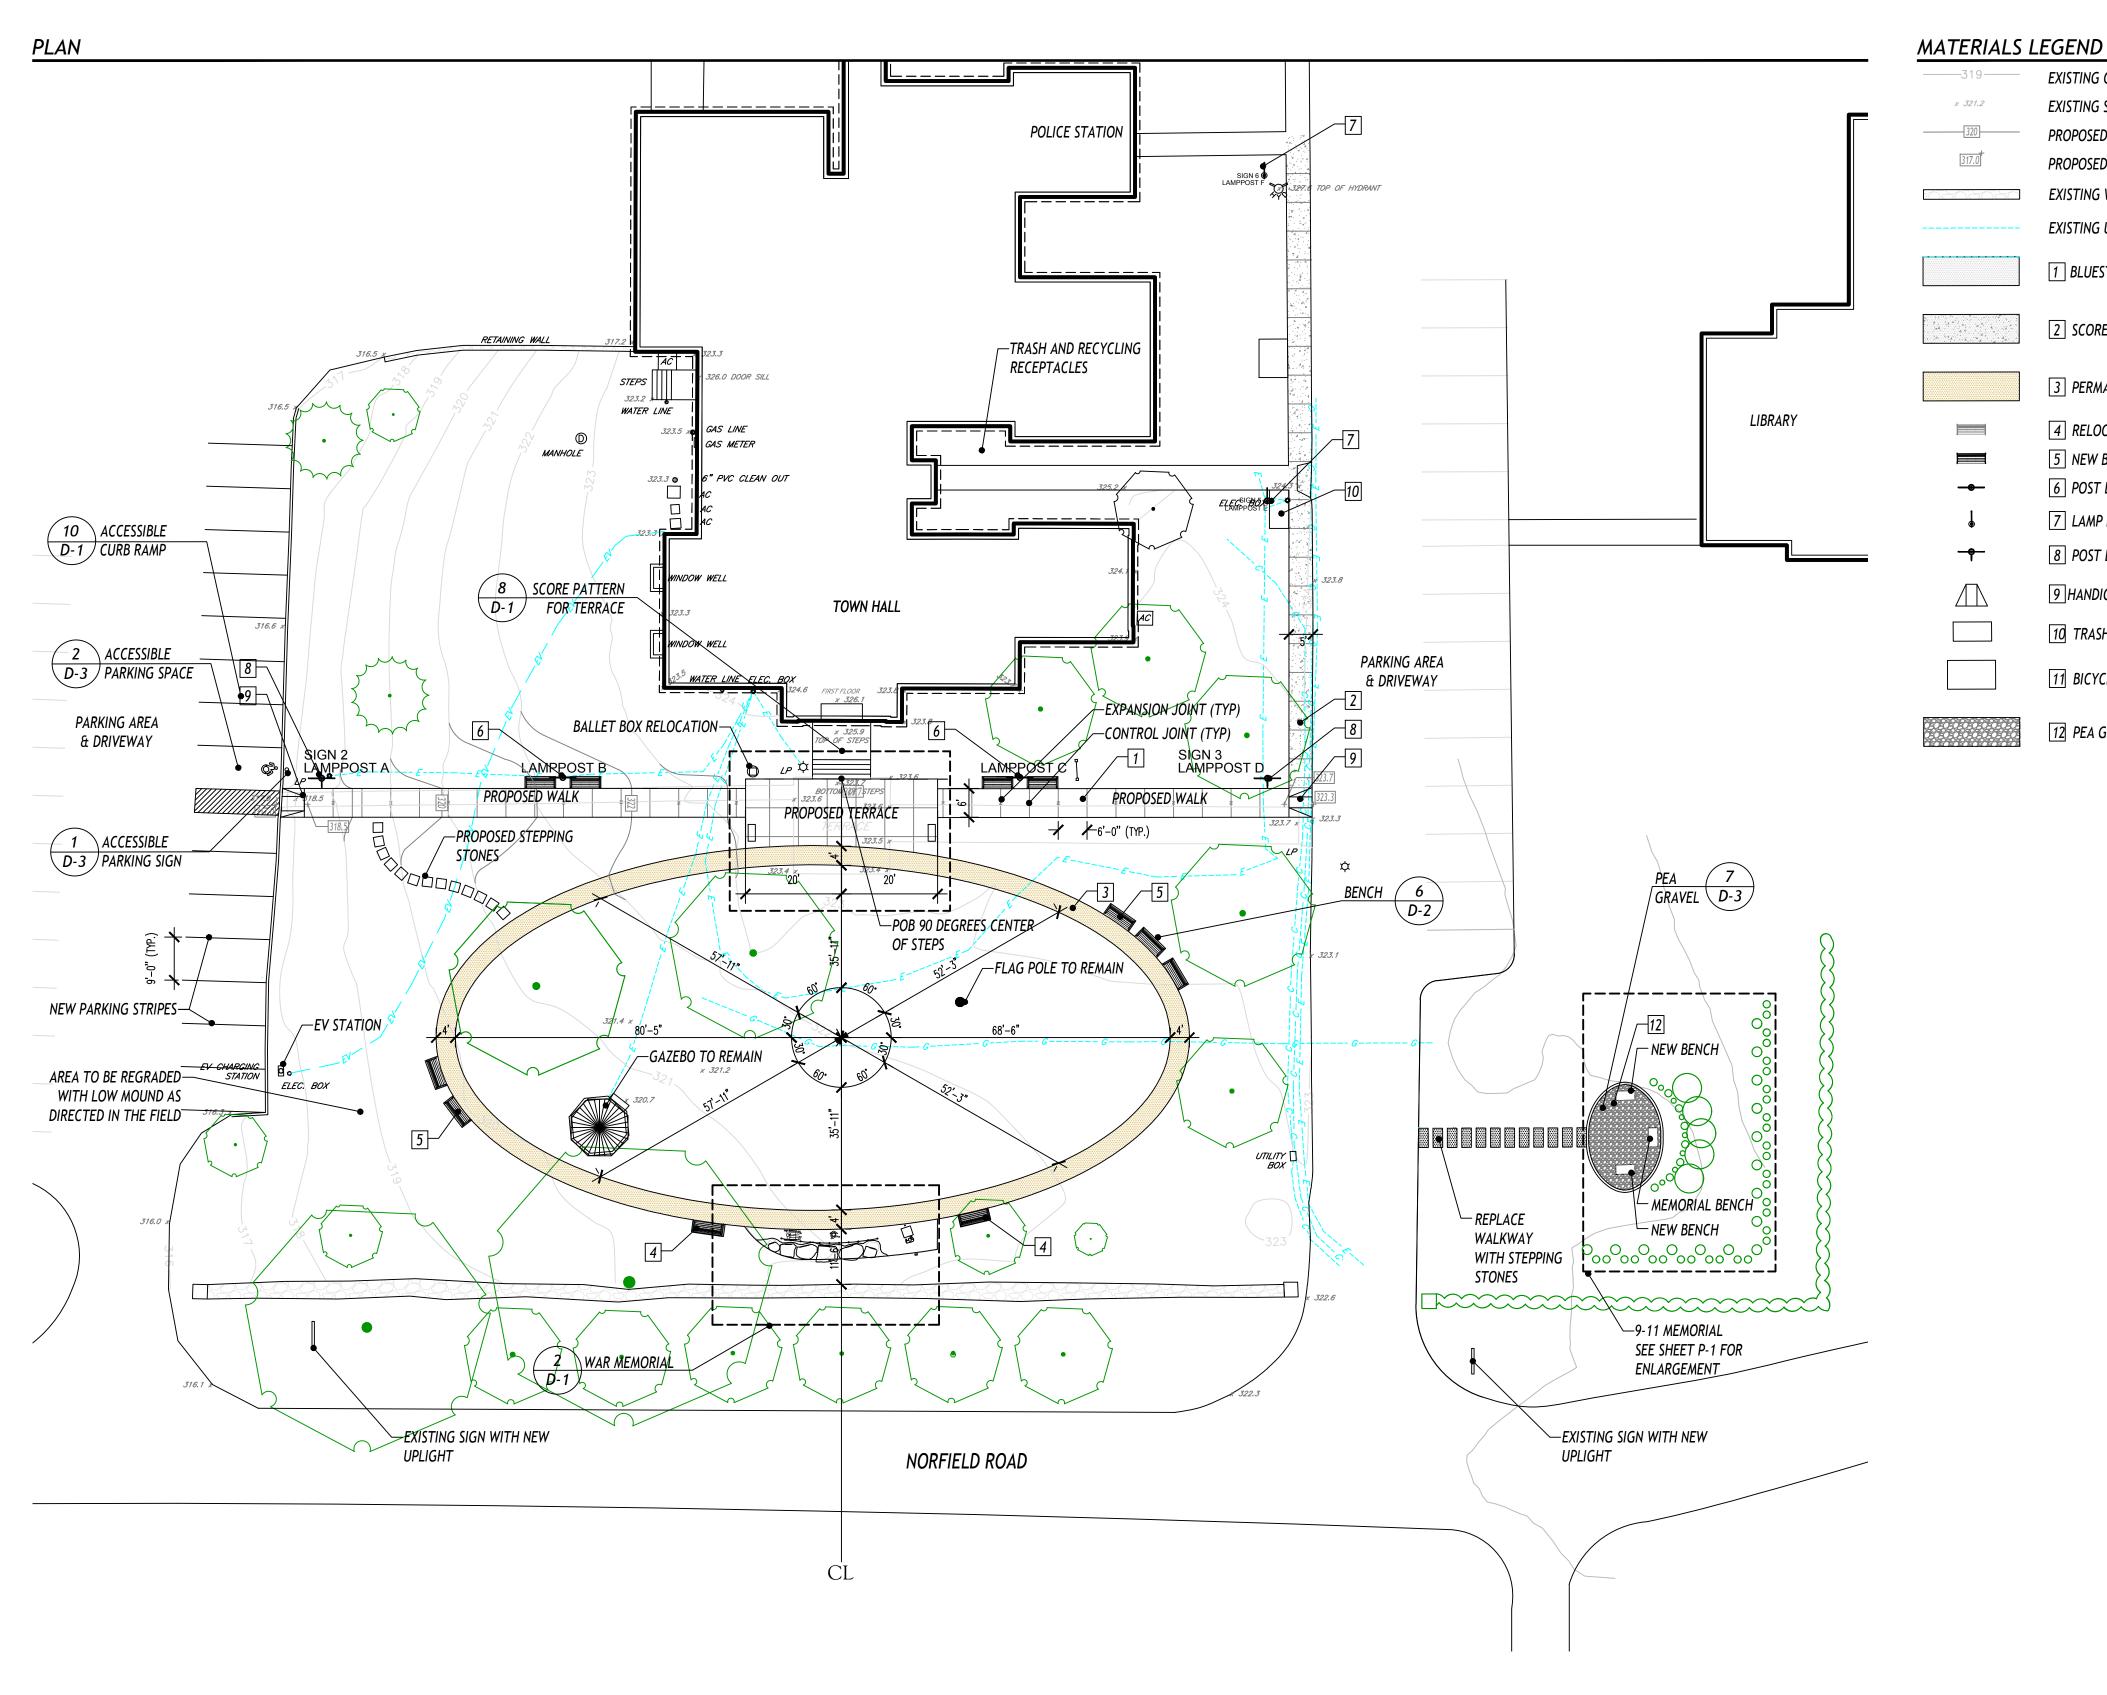

GENERAL NOTES

1. FINAL LOCATION OF LIGHTS, GFCI OUTLETS, BENCHES AND RELOCATED BENCHES APPROVED BY

LANDSCAPE ARCHITECT.

2. SEE SHEET E-2 FOR ELECTRIC PLAN.

3 PERMADRIVE PAVING

2 SCORED CONCRETE PAVING

1 BLUESTONE PAVEMENT SCORED CONCRETE

4 RELOCATED BENCH 5 NEW BENCH

EXISTING CONTOUR

EXISTING SPOT GRADE

PROPOSED CONTOUR

EXISTING WALL

EXISTING UTILITY

PROPOSED SPOT GRADE

6 POST LIGHT WITH BANNER ARMS

7 LAMP POST WITH SIGN

8 POST LIGHT WITH BANNER ARMS AND SIGN

9 HANDICAP RAMP

10 TRASH AND RECYCLING RECEPTACLES ON 4'X8' CONCRETE PAD

11 BICYCLE RACK ON 6'X10' CONCRETE PAD

12 PEA GRAVEL

WILLIAM KENNY ASSOCIATES

LANDSCAPE ARCHITECTURE • ECOLOGICAL SERVICES

1899 Bronson Road Fairfield CT 06824 203 366 0588 www.wkassociates.net

PROJECT:

WESTON TOWN GREEN

OWNER / CLIENT:

WESTON BEAUTIFICATION COMMITTEE

56 NORFIELD ROAD WESTON, CT

DESIGN ARCHITECT:

THIEL ARCHITECTURE + DESIGN

1480 POST ROAD EAST 5A WESTPORT, CT

HORTICULTURAL DESIGNER:

KARIN'S GARDEN DESIGN

14 STONEHENGE ROAD WESTON, CT

MEMORIAL DESIGNER:

JULIE HANSELMANN DAVIES

57 PARK TERRACE EAST B27 NEW YORK, NY

ELECTRICAL ENGINEER:

SG ENGINEERING

56 FOXCROFT COURT SOUTHINGTON, CT


PROGRESS ISSUE:

1 ISSUED FOR BID

02/10/2023

KEY PLAN:


SCALE: |0' |10' |20'

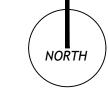

SHEET TITLE:

LAYOUT, MATERIALS, & GRADING PLAN

SHEET NUMBER:

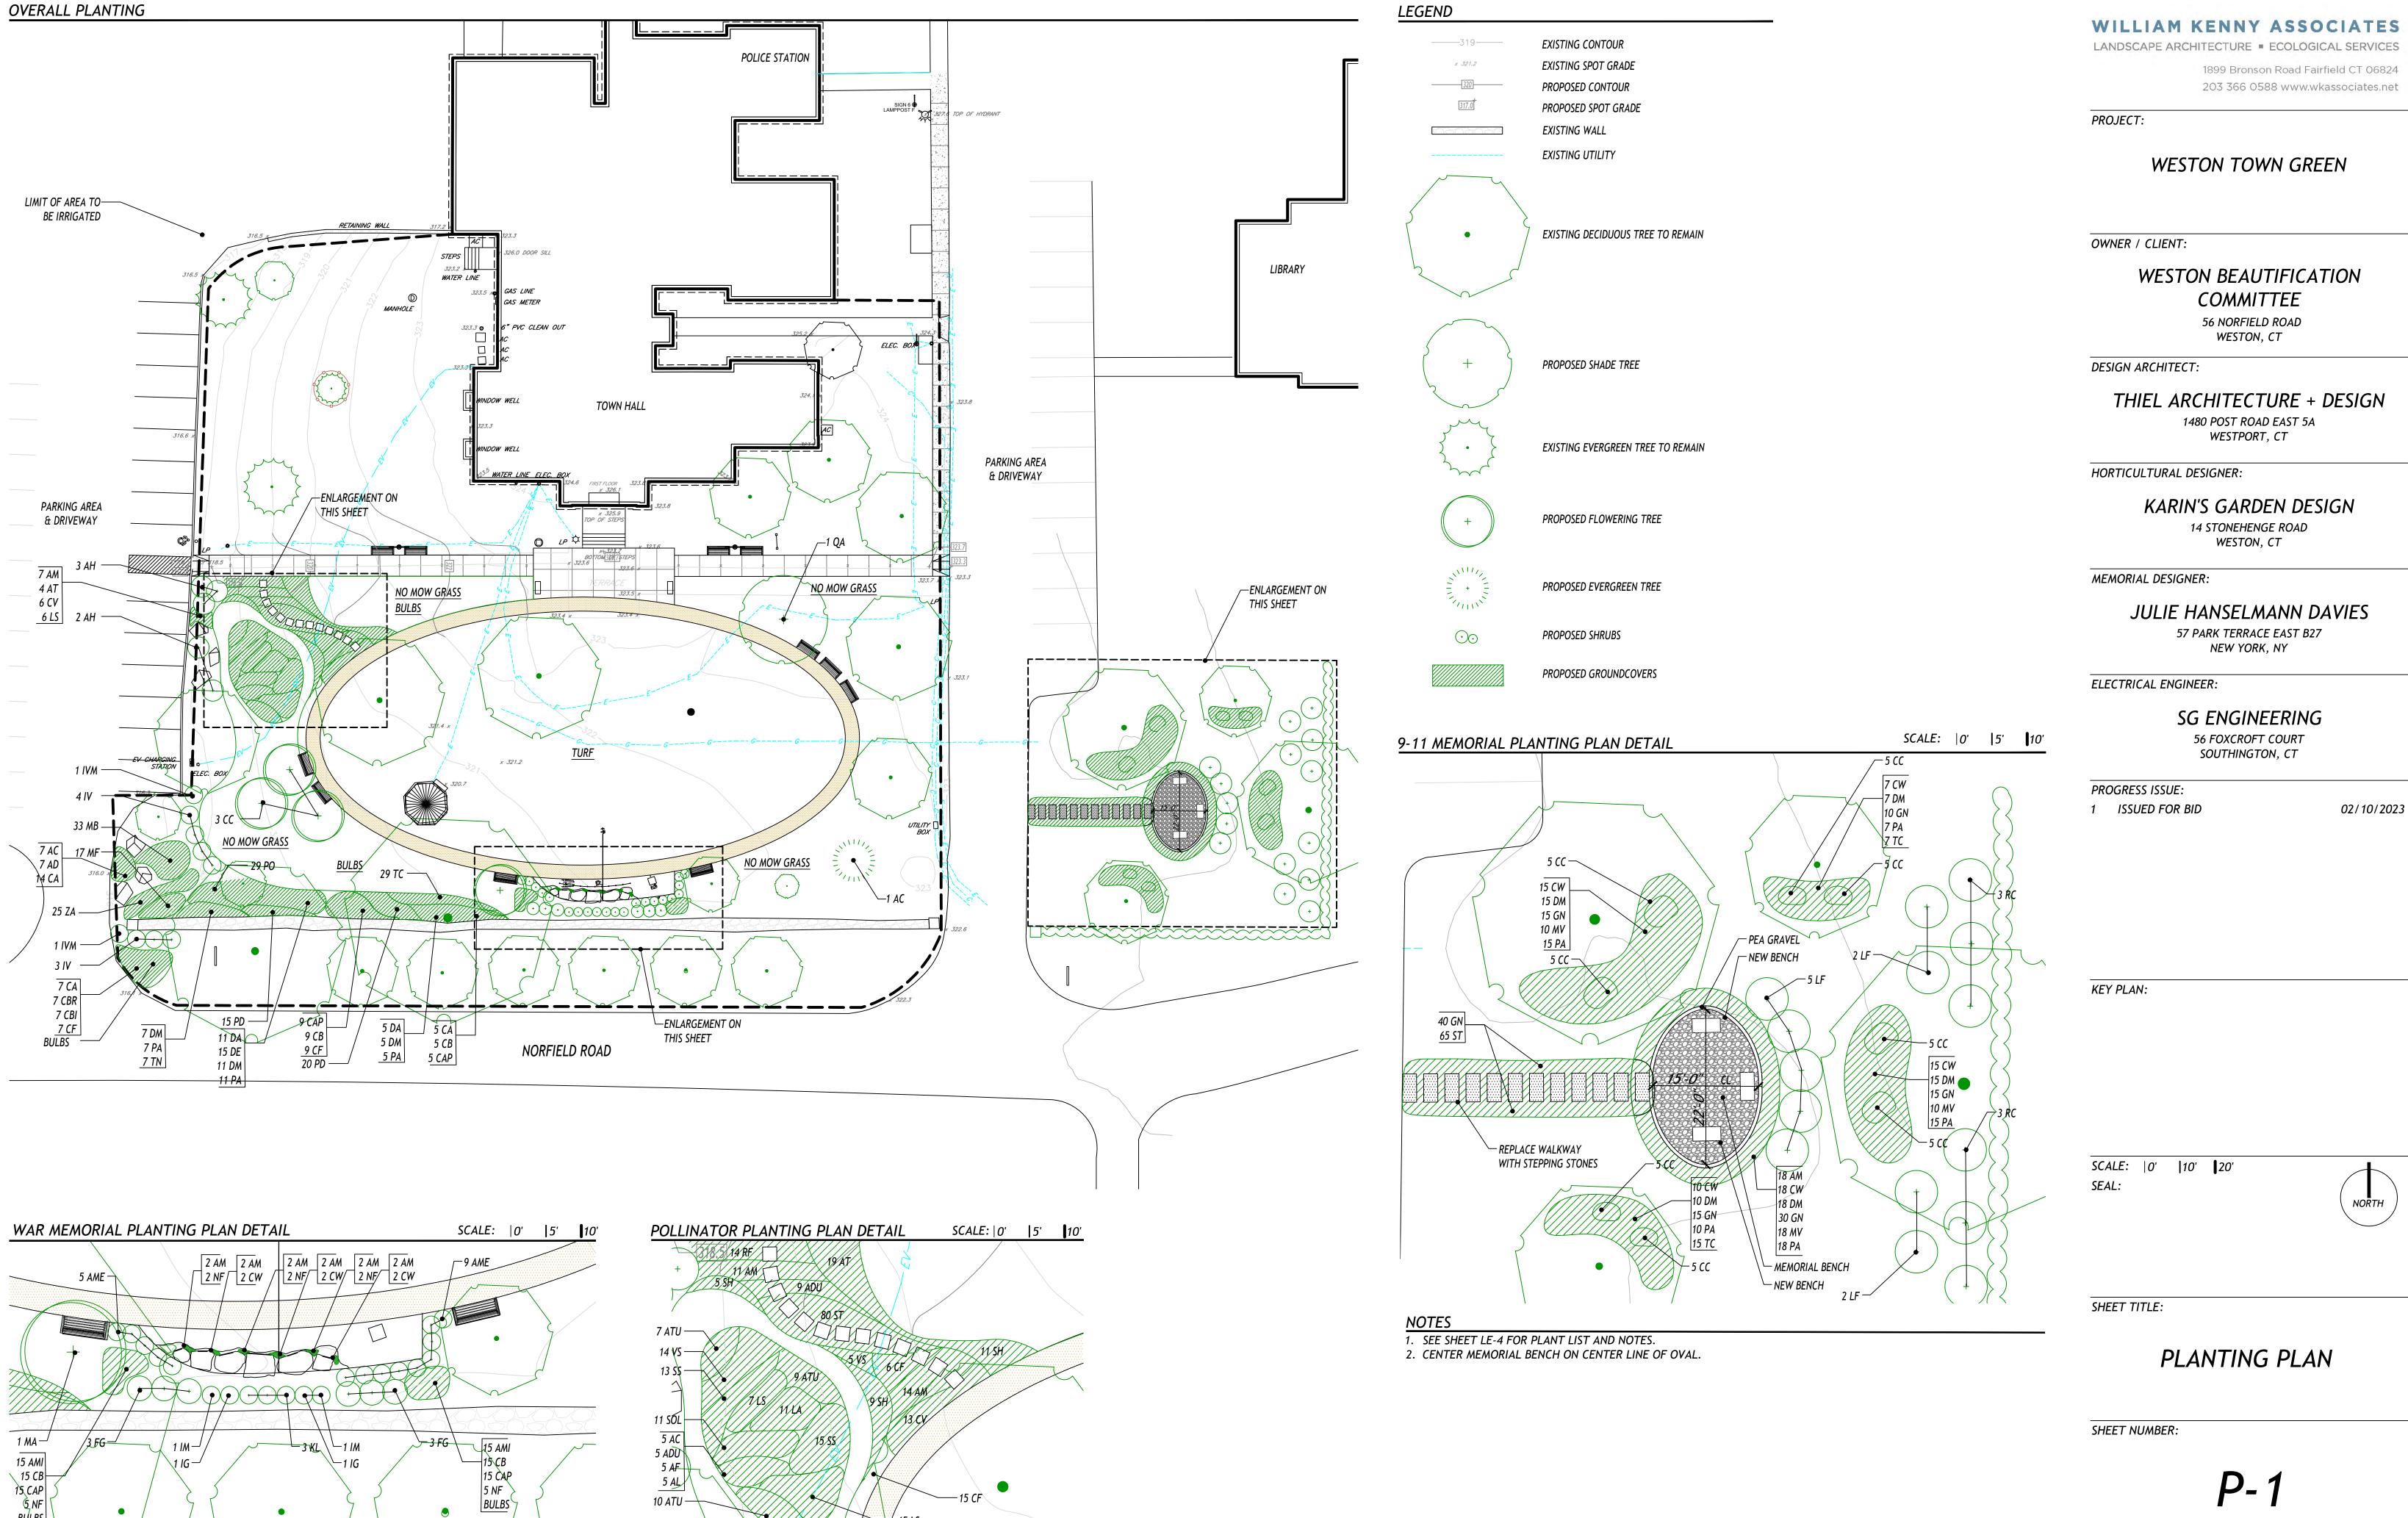

PLANT LIST: PERENNIAL GARDEN

VERTICILLATA 'SPRITE'	SPRITE WINTERBERRY	2'-3' HT.	CONTAINER
VERTICILLATA 'JIM DANDY'	JIM DANDY WINTERBERRY	2'-3' HT.	CONTAINER
, GRASSES, AND FERNS			
LLEA MILLEFOLIUM 'HELLA GLASHOFF'	HELLA GLASHOFF YARROW	1 GAL.	CONTAINER
STACHE 'BLUE FORTUNE'	BLUE FORTUNE HYSSOP	1 GAL.	CONTAINER
ONIA HUBRECTII	BLUESTAR	1 GAL.	CONTAINER
ROPOGON TERNARIUS	BLACK MOUNTAIN BLUESTEM	1 GAL.	CONTAINER
EPIAS TUBEROSA	MILKWEED	1 GAL.	CONTAINER
R CORDIFOLIUS 'LITTLE CARLOW'	LITTLE CARLOW ASTER	1 GAL.	CONTAINER
R DUMOSUS	WOODS BLUE	1 GAL.	CONTAINER
R FRIKARTLI 'MONCH'	MONCH ASTER	1 GAL.	CONTAINER
R LAEVIS	SMOOTH ASTER	1 GAL.	CONTAINER
EX FLACCOSPERMA	BLUE WOOD SEDGE	2 QUART.	CONTAINER
EOPSIS VERTICILATA 'ZAGREB'	ZAGREB TICKSEED	1 GAL.	CONTAINER
HAMPSIA CEPITOSA 'GOLDTAU'	GOLDTAU TUFTED HAIRGRASS	1 GAL.	CONTAINER
RIS ASPERA	ROUGH BLAZING STAR	1 GAL.	CONTAINER
RIS SPICATA	DENSE BLAZING STAR	1 GAL.	CONTAINER
BEKIA FULGIDA VAR FULGIDA	BLACK-EYED SUSAN	1 GAL.	CONTAINER
ZACHYRIUM SCOPARIUM	BLUEGRASS	1 GAL.	CONTAINER
POBOLUS HETEROLEPIS	PRAIRIE DROPSEED 1 GAL.		CONTAINER
M TERNATUM	STONECROP	1 GAL.	CONTAINER
ONIA SWAN SONG	IRONWEED	1 GAL.	CONTAINER
1/	M TERNATUM	M TERNATUM STONECROP	M TERNATUM STONECROP 1 GAL.

"NO MOW LAWN SEED MIX WITH RYE" AS PRODUCED BY PRAIRIE NURSERY (WWW.PRAIRIENURSERY.COM). APPLIED AT A RATE OF 5 LBS/700

SQUARE FEET.

PLANT LIST: OVERALL PLAN

SYM.	QTY.	SCIENTIFIC NAME	COMMON NAME	SIZE	ROOT
PROPOSI	ED SHA	DE TREE			
QA	1	QUERCUS ALBA	WHITE OAK	2"-2.5" CAL.	B&B
TOTAL	1				
PROPOSI	ED EVE	RGREEN TREE			
AC	1	ABIES CONCOLOR	WHITE FIR	2"-2.5" CAL.	B&B
TOTAL	1				
PROPOSI	ED SHR	UBS			
IV	3	ILEX VERTICILLATA 'SPRITE'	SPRITE WINTERBERRY	2'-3' HT.	CONTAINER
IVM	1	ILEX VERTICILLATA 'JIM DANDY'	JIM DANDY WINTERBERRY	2'-3' HT.	CONTAINER
TOTAL	4				
PROPOSI	ED PERI	ENNIAL, GRASSES, AND FERNS			
AC	7	ASTER CORDIFOLIUS 'LITTLE CARLOW'	LITTLE CARLOW ASTER	1 GAL.	CONTAINER
AD	7	ARUNCUS DIOICUS	GOATSBEARD	1 GAL.	CONTAINER
CA	26	CAREX ALBICANS	WHITE TINGED SEDGE	2 QUART.	CONTAINER
DE	15	DRYOPTERIS ERYTHROSORA 'AUTUMN BRILLIANCE'	BRILLIANCE AUTUMN FERN	1 GAL.	CONTAINER
DM	23	DRYOPTERIS MARGINALIS	MARGINAL WOOD FERN	1 GAL.	CONTAINER
PO	29	PACKERA OBOVATA	GROUNDSEL	1 GAL.	CONTAINER
PD	35	PHLOX DIVARICATA	WOODLAND PHLOX	1 GAL.	CONTAINER
PA	23	POLYSTICHUM ACROSTICHOIDES	CHRISTMAS FERN	1 GAL.	CONTAINER
TN	7	THELYPTERIS NOVEBORACENSIS	NEW YORK FERN	1 GAL.	CONTAINER
ZA	25	ZIZIA APTERA	HEART-LEAVED ALEXANDER	1 GAL.	CONTAINER
TOTAL	197				
ANNUAL	S				
GL	35	GAURA LINDHEIMERI	BEEBLOSSOM	1 GAL.	CONTAINER
VB	35	VERBENA BONARIENSIS	PURPLETOP VERVAIN	1 GAL.	CONTAINER
TOTAL	70				

PLANT LIST: WAR MEMORIAL

	QTY.	SCIENTIFIC NAME	COMMON NAME	SIZE	ROOT
WAR M	EMORIA	L PLANTINGS			
PROPO	SED TRE	ES			
MA	1	MALUS 'ADIRONDACK'	ADIRONDACK CRABAPPLE	8'-10' HT.	B&B
TOTAL	1				
PROPOS	ED SHRU	JBS			
AME	14	ARONIA MELANOCARPA 'LOWSCAPE MOUND'	LOWSCAPE MOUND CHOKECHERRY	2'-3' HT.	CONTAINER
FG	6	FOTHERGILLA GARDENII	DWARF FOTHERGILLA	2'-3' HT.	CONTAINER
IG	2	ILEX GABRA 'SHAMROCK'	SHAMROCK INKBERRY	2'-3' HT.	CONTAINER
IM	2	ILEX X MESERVAE 'CASTLE SPIRE'	CASTLE SPIRE BLUE HOLLY	5'-6' HT.	CONTAINER
KL	3	KALMIA LATIFOLIA	MOUNTAIN LAUREL	2'-3' HT.	CONTAINER
TOTAL	27				
PROPOS	ED PERE	NNIALS AROUND BOULDERS			
AM	12	ALLIUM MILLENIUM	ORNAMENTAL ONION	1 GAL.	CONTAINER
CW	6	CAREX WOODII	WHITE TINGED SEDGE	1 GAL.	CONTAINER
NF	6	NEPETA FAASSENII 'PURRSIAN BLUE'	PURRSIAN BLUE CATMINT	1 GAL.	CONTAINER
TOTAL	24				
9/11 M	EMORIA	L PLANTINGS			
	ED SHRU	JBS			
	ED SHRU	UBS LEUCOTHOE FONTANESIANA	DROOPING LAUREL	4'-5' HT.	CONTAINER
PROPOS			DROOPING LAUREL CUNNINGHAMS' WHITE RHODODENDRON	4'-5' HT. 4'-5' HT.	
PROPOS LF	9	LEUCOTHOE FONTANESIANA			
PROPOS LF RC TOTAL	9 6 15	LEUCOTHOE FONTANESIANA			CONTAINER
PROPOS LF RC TOTAL	9 6 15	RHODODENDRON 'CUNNINHAM'S WHITE'			F-40-75
PROPOS LF RC TOTAL PROPOS	9 6 15 SED PERE	LEUCOTHOE FONTANESIANA RHODODENDRON 'CUNNINHAM'S WHITE' ENNIAL, GRASSES, AND FERNS	CUNNINGHAMS' WHITE RHODODENDRON	4'-5' HT.	CONTAINER
PROPOS LF RC TOTAL PROPOS	9 6 15 EED PERE 18	LEUCOTHOE FONTANESIANA RHODODENDRON 'CUNNINHAM'S WHITE' ENNIAL, GRASSES, AND FERNS ALCHEMILLA MOLLIS	CUNNINGHAMS' WHITE RHODODENDRON LADY'S MANTLE	4'-5' HT. 1 GAL.	CONTAINER CONTAINER CONTAINER
PROPOS LF RC TOTAL PROPOS AM	9 6 15 SED PERE 18 40	ENNIAL, GRASSES, AND FERNS ALCHEMILLA MOLLIS CORNUS CANADENSIS	CUNNINGHAMS' WHITE RHODODENDRON LADY'S MANTLE BUNCHBERRY	4'-5' HT. 1 GAL. 1 GAL.	CONTAINER CONTAINER CONTAINER CONTAINER
PROPOS LF RC TOTAL PROPOS AM CC CW	9 6 15 SED PERE 18 40 65	ENNIAL, GRASSES, AND FERNS ALCHEMILLA MOLLIS CORNUS CANADENSIS CAREX WOODII	CUNNINGHAMS' WHITE RHODODENDRON LADY'S MANTLE BUNCHBERRY WHITE TINGED SEDGE	4'-5' HT. 1 GAL. 1 GAL. 1 QUART.	CONTAINER CONTAINER CONTAINER CONTAINER
PROPOS LF RC TOTAL PROPOS AM CC CW DM	9 6 15 EED PERE 18 40 65 65	ENNIAL, GRASSES, AND FERNS ALCHEMILLA MOLLIS CORNUS CANADENSIS CAREX WOODII DRYOPTERIS MARGINALIS	CUNNINGHAMS' WHITE RHODODENDRON LADY'S MANTLE BUNCHBERRY WHITE TINGED SEDGE MARGINAL WOOD FERN	1 GAL. 1 GAL. 1 GAL. 1 QUART. 1 GAL.	CONTAINER CONTAINER CONTAINER CONTAINER CONTAINER
PROPOS LF RC TOTAL PROPOS AM CC CW	9 6 15 EED PERE 18 40 65 65 38	LEUCOTHOE FONTANESIANA RHODODENDRON 'CUNNINHAM'S WHITE' ENNIAL, GRASSES, AND FERNS ALCHEMILLA MOLLIS CORNUS CANADENSIS CAREX WOODII DRYOPTERIS MARGINALIS MERTENSIA VIRGINICA	CUNNINGHAMS' WHITE RHODODENDRON LADY'S MANTLE BUNCHBERRY WHITE TINGED SEDGE MARGINAL WOOD FERN VIRGINIA BLUEBELLS	1 GAL. 1 GAL. 1 QUART. 1 GAL. 1 GAL.	CONTAINER CONTAINER CONTAINER CONTAINER CONTAINER CONTAINER
PROPOSILF RC TOTAL PROPOSI AM CC CW DM MV PA TC	9 6 15 EED PERE 18 40 65 65 38 65	ENNIAL, GRASSES, AND FERNS ALCHEMILLA MOLLIS CORNUS CANADENSIS CAREX WOODII DRYOPTERIS MARGINALIS MERTENSIA VIRGINICA POLYSTICHUM ACROSTICHOIDES	CUNNINGHAMS' WHITE RHODODENDRON LADY'S MANTLE BUNCHBERRY WHITE TINGED SEDGE MARGINAL WOOD FERN VIRGINIA BLUEBELLS CHRISTMAS FERN	1 GAL. 1 GAL. 1 QUART. 1 GAL. 1 GAL.	CONTAINER CONTAINER CONTAINER CONTAINER CONTAINER CONTAINER CONTAINER
PROPOS LF RC TOTAL PROPOS AM CC CW DM MV PA TC	9 6 15 EED PERE 18 40 65 65 38 65 22	LEUCOTHOE FONTANESIANA RHODODENDRON 'CUNNINHAM'S WHITE' ENNIAL, GRASSES, AND FERNS ALCHEMILLA MOLLIS CORNUS CANADENSIS CAREX WOODII DRYOPTERIS MARGINALIS MERTENSIA VIRGINICA POLYSTICHUM ACROSTICHOIDES TIARELLA CORDIFOLIA	CUNNINGHAMS' WHITE RHODODENDRON LADY'S MANTLE BUNCHBERRY WHITE TINGED SEDGE MARGINAL WOOD FERN VIRGINIA BLUEBELLS CHRISTMAS FERN FOAM FLOWER	1 GAL. 1 GAL. 1 QUART. 1 GAL. 1 GAL. 1 GAL.	CONTAINER CONTAINER CONTAINER CONTAINER CONTAINER CONTAINER CONTAINER CONTAINER
PROPOSILF RC TOTAL PROPOSI AM CC CW DM MV PA TC ST TOTAL	9 6 15 EED PERE 18 40 65 65 38 65 22 65	LEUCOTHOE FONTANESIANA RHODODENDRON 'CUNNINHAM'S WHITE' ENNIAL, GRASSES, AND FERNS ALCHEMILLA MOLLIS CORNUS CANADENSIS CAREX WOODII DRYOPTERIS MARGINALIS MERTENSIA VIRGINICA POLYSTICHUM ACROSTICHOIDES TIARELLA CORDIFOLIA	CUNNINGHAMS' WHITE RHODODENDRON LADY'S MANTLE BUNCHBERRY WHITE TINGED SEDGE MARGINAL WOOD FERN VIRGINIA BLUEBELLS CHRISTMAS FERN FOAM FLOWER	1 GAL. 1 GAL. 1 QUART. 1 GAL. 1 GAL. 1 GAL. 1 GAL.	CONTAINER CONTAINER CONTAINER CONTAINER CONTAINER CONTAINER CONTAINER CONTAINER
PROPOS LF RC TOTAL PROPOS AM CC CW DM MV PA	9 6 15 EED PERE 18 40 65 65 38 65 22 65	LEUCOTHOE FONTANESIANA RHODODENDRON 'CUNNINHAM'S WHITE' ENNIAL, GRASSES, AND FERNS ALCHEMILLA MOLLIS CORNUS CANADENSIS CAREX WOODII DRYOPTERIS MARGINALIS MERTENSIA VIRGINICA POLYSTICHUM ACROSTICHOIDES TIARELLA CORDIFOLIA	CUNNINGHAMS' WHITE RHODODENDRON LADY'S MANTLE BUNCHBERRY WHITE TINGED SEDGE MARGINAL WOOD FERN VIRGINIA BLUEBELLS CHRISTMAS FERN FOAM FLOWER	1 GAL. 1 GAL. 1 QUART. 1 GAL. 1 GAL. 1 GAL. 1 GAL.	CONTAINER

PLANT LIST: 9-11 MEMORIAL

SYM.	QTY.	SCIENTIFIC NAME	COMMON NAME	SIZE	ROOT
PROPOS	ED SHRU	JBS			
LF	9	LEUCOTHOE FONTANESIANA	DROOPING LAUREL	4'-5' HT.	CONTAINER
RC	6	RHODODENDRON 'CUNNINHAM'S WHITE'	CUNNINGHAMS' WHITE RHODODENDRON	4'-5' HT.	CONTAINER
TOTAL	15				
PROPOS	ED PERE	ENNIAL, GRASSES, AND FERNS			
AM	18	ALCHEMILLA MOLLIS	LADY'S MANTLE	1 GAL.	CONTAINER
СС	40	CORNUS CANADENSIS	BUNCHBERRY	1 GAL.	CONTAINER
CW	65	CAREX WOODII	WHITE TINGED SEDGE	1 QUART.	CONTAINER
DM	65	DRYOPTERIS MARGINALIS	MARGINAL WOOD FERN	1 GAL.	CONTAINER
MV	38	MERTENSIA VIRGINICA	VIRGINIA BLUEBELLS	1 GAL.	CONTAINER
PA	65	POLYSTICHUM ACROSTICHOIDES	CHRISTMAS FERN	1 GAL.	CONTAINER
TC	22	TIARELLA CORDIFOLIA	FOAM FLOWER	1 GAL.	CONTAINER
ST	65	SEDUM TERNATUM	WOODLAND STONECROP	1 GAL.	CONTAINER
TOTAL	378			1 GAL.	CONTAINER
BULBS					
GL	40	GALANTHUS NIVALIS	SNOW DROPS		CONTAINER
TOTAL	40				

PLANTING NOTES

- 1. PROPOSED TREE AND SHRUB LOCATIONS TO BE ADJUSTED IN FIELD AS NEEDED BASED ON FIELD
- CONDITIONS.
- 2. PLANT SPACING FOR HERBACEOUS MATERIAL TO BE 24" O.C. BOTANICAL NAMES SHALL PREVAIL OVER COMMON NAMES.
- 4. ALL PLANT MATERIAL SHALL BE NURSERY GROWN; NO COLLECTED MATERIALS SHALL BE ACCEPTED, UNLESS SPECIFICALLY INDICATED.
- 5. PLANTS SHALL CONFORM TO THE AMERICAN ASSOCIATION OF NURSERYMEN STANDARDS IN ALL WAYS INCLUDING DIMENSIONS.
- 6. THE LANDSCAPE ARCHITECT HAS THE RIGHT TO REJECT ANY PLANT MATERIALS UPON DELIVERY TO THE PROJECT. SELECTION BY THE LANDSCAPE ARCHITECT DOES NOT WAIVE THE RIGHT OF REJECTION.
- 7. ALL REPLACEMENTS SHALL BE PLANTS OF THE SAME KIND AND SIZE AS SPECIFIED IN THE PLANT LIST OR AS NECESSARY TO MATCH SURVIVING PLANTS OF THE SAME PLANTING GROUP. ALL COSTS SHALL BE BORN BY THE LANDSCAPE CONTRACTOR EXCEPT FOR REPLACEMENTS RESULTING FROM LOSS OR DAMAGE DUE TO VANDALISM OR ACTS OF NEGLECT ON THE PART OF OTHERS, PHYSICAL DAMAGE, BY ANIMALS, VEHICLES, FIRE, ETC., AS MAY BE DETERMINED BY THE LANDSCAPE ARCHITECT.
- 8. ALL PLANT MATERIAL SHOULD BE PLACED, OR LOCATION STAKED, ON THE SITE AS SHOWN ON THE PLANTING PLAN PRIOR TO COMMENCEMENT OF PLANT EXCAVATION FOR THE LANDSCAPE ARCHITECT'S APPROVAL. THE CONTRACTOR MUST NOTIFY THE LANDSCAPE ARCHITECT OF ALL PLANTING OPERATIONS A MINIMUM OF 48 HOURS IN ADVANCE.
- ALL PLANT MATERIALS SHALL BE BALLED AND BURLAPPED OR CONTAINER GROWN OR AS OTHERWISE SPECIFIED. NO CONSTRUCTED BALLS SHALL BE ACCEPTED. REMOVE SYNTHETIC 'BURLAP' AND SYNTHETIC TWINES AND ROPES. REMOVE TOP 1/3 OF METAL BASKETS FROM ROOT BALLS WHEN THE ROOT BALL HAS BEEN POSITIONED IN THE PLANTING PIT. PROVIDE SUPPORT AS NECESSARY TO PROTECT THE ROOT BALL FROM INJURY DURING THIS OPERATION.

IRRIGATION PERFORMANCE SPECIFICATIONS

1.1 SECTION INCLUDES

A. IRRIGATION SYSTEM EIGHT ZONE UNDERGROUND IRRIGATION SYSTEM WITH 2 QUICK COUPLER HOSE BIBS.

SYSTEM SHALL INCLUDE ALL LAWN AND PLANT BEDS WITHIN THE PROJECT LIMITS. NOTE THE MEADOW AREA SHALL BE TEMPORARY UNTIL THE MEADOW IS ESTABLISHED.

1.2 RELATED SECTIONS

A. SECTION 02300 - EARTHWORK FOR SUBSTRATE AND GRADING.

1.3 SUBMITTALS

SUBMIT UNDER PROVISIONS OF SECTION 01200SUBMITTALS. PRODUCT DATA: MANUFACTURER'S DATA SHEETS ON EACH PRODUCT TO BE USED, INCLUDING:

PREPARATION INSTRUCTIONS AND RECOMMENDATIONS

STORAGE AND HANDLING REQUIREMENTS AND RECOMMENDATIONS

B.C. INSTALLATION METHODS

SHOP DRAWINGS: SUBMIT SHOP DRAWINGS INDICATING MATERIAL CHARACTERISTIC, DETAILS OF CONSTRUCTION, CONNECTIONS, AND RELATIONSHIP WITH ADJACENT CONSTRUCTION.

WARRANTY: SUBMIT MANUFACTURERS STANDARD WARRANTY. INCLUDE LABOR AND MATERIALS TO REPAIR OR REPLACE

DEFECTIVE MATERIALS. WARRANTY PERIOD: 5 YEARS OPERATION AND MAINTENANCE DATA: SUBMIT MANUFACTURERS OPERATION AND MAINTENANCE DATA, INCLUDING

OPERATING INSTRUCTIONS, LIST OF SPARE PARTS AND MAINTENANCE SCHEDULE.

1.4 QUALITY ASSURANCE

A. MANUFACTURERS' QUALIFICATIONS: MINIMUM FIVE YEAR EXPERIENCE MANUFACTURER SIMILAR PRODUCTS.

INSTALLER QUALIFICATIONS: MINIMUM 2 YEAR EXPERIENCE INSTALLING SIMILAR PRODUCTS. SHALL BE A EPA WATERSENSE PARTNER.

WATER COVERAGE FOR TUF AREAS: 100 PERCENT. WATER COVERAGE FOR PLANTING AREAS: 100 PERCENT

TESTING: HYDROSTATIC TEST AT 100 PSI.

1.5 PRE-INSTALLATION MEETINGS

A. CONVENE MINIMUM TWO WEEKS PRIOR TO STARTING WORK OF THIS SECTION.

1.6 DELIVERY, STORAGE, AND HANDLING

A. DELIVER AND STORE PRODUCTS IN MANUFACTURERS UNOPENED PACKAGING BEARING THE BRAND NAME AND MANUFACTURERS

IDENTIFICATION UNTIL READY FOR INSTALLATION.

HANDLING: HANDLE MATERIALS TO AVOID DAMAGE.

1.7 PROJECT CONDITIONS

A. MAINTAIN ENVIRONMENTAL CONDITIONS(TEMPERATURE, HUMIDITY, AND VENTILATION) WITHIN LIMITS RECOMMENDED BY MANUFACTURER FOR OPTIMUM RESULTS. DO NOT INSTALL PRODUCTS UNDER ENVIRONMENTAL CONDITIONS OUTSIDE MANUFACTURE'S RECOMMENDED LIMITS.

1.8 SEQUENCING

ENSURE THAT PRODUCTS OF THIS SECTION ARE SUPPLIED TO AFFECTED TRADES IN TIME TO PREVENT INTERUPPTION OF CONSTRUCTION PROGRESS.

PART 2: PRODUCTS

2.1 MANUFACTURERS

A. ACCEPTABLE MANUFACTURERS: TORO COMPANY, HUNDER INDUSTRIES

SUBSTITUTIONS: NOT PERMITTED

REQUESTS FOR SUBSTITUTIONS WILL BE CONSIDERED IN ACCORDANCE WITH PROVISIONS OF SECTION 01600.

2.2 MATERIALS

IRRIGATION SYSTEM:

A.A. PIPING: PVC PLASTIC.

VALVES: CAST BRONZE.

BACKFLOW PREVENTERS: CAST BRONZE.

SPRINKLER HEADS: SUITABLE FOR SERVICE.

5. AUTOMATIC CONTROL SYSTEM: EXTERIOR LOCATION WITH SOL MOISTER SENSOR.

PART 3: EXECUTION

3.1 EXAMINATION

A. DO NOT BEGIN INSTALLATION UNTIL SUBSTRATES HAVE BEEN PROPERLY PREPARED.

IF SUBSTRATE PREPARATION IS THE RESPONSIBILITY OF ANOTHER INSTALLER, NOTIFY LANDSCAPE ARCHITECT OF UNSATISFACTORY PREPARATION BEFORE PROCEEDING.

3.2 PREPARATION

A. CLEAN SURFACES THOROUGHLY PRIOR TO INSTALLATION. PREPARE SURFACES USING THE METHODS RECOMMENDED BY THE MANUFACTURER FOR ACHIEVING THE BEST RESULT UNDER THE PROJECT CONDITIONS.

3.3 INSTALLATION

PROTECT EXISTING LANDSCAPING FROM DAMAGE. REPAIR AND REPAVE CUT PAVING TO MATCH PAVING IN ORIGINAL CONDITION.

INSTALL MATERIALS AND SYSTEMS IN ACCORDANCE WITH MANUFACTURER'S INSTRUCTIONS AND APPROVED SUBMITTALS. INSTALL

MATERIALS & SYSTEMS IN PROPER RELATION WITH ADJACENT CONSTRUCTION. COORDINATE WITH WORK OF OTHER SECTIONS. RESTORE DAMAGED COMPONENTS AND TEST FOR PROPER OPERATION. CLEAN OUT SYSTEM AND PROTECT WORK FROM DAMAGE.

INSTRUCT OWNER'S PERSONNEL IN PROPER OPERATION AND MAINTENANCE PROCEDURES.

3.4 PROTECTION

A. PROTECT INSTALLED PRODUCTS UNTIL COMPLETION OF PROJECT.

B. TOUCH-UP, REPAIR, OR REPLACE DAMAGED PRODUCTS BEFORE SUBSTANTIAL COMPLETION. **END OF SECTION**

PLANTING LIST AND

SHEET NUMBER:

REF. NO. 5396

WILLIAM KENNY ASSOCIATES

LANDSCAPE ARCHITECTURE

ECOLOGICAL SERVICES 1899 Bronson Road Fairfield CT 06824

203 366 0588 www.wkassociates.net

PROJECT:

WESTON TOWN GREEN

OWNER / CLIENT:

WESTON BEAUTIFICATION COMMITTEE

> 56 NORFIELD ROAD WESTON, CT

DESIGN ARCHITECT:

THIEL ARCHITECTURE + DESIGN

1480 POST ROAD EAST 5A WESTPORT, CT

HORTICULTURAL DESIGNER:

KARIN'S GARDEN DESIGN

14 STONEHENGE ROAD WESTON, CT

MEMORIAL DESIGNER:

JULIE HANSELMANN DAVIES *57 PARK TERRACE EAST B27*

NEW YORK, NY

ELECTRICAL ENGINEER:

1 ISSUED FOR BID

SG ENGINEERING 56 FOXCROFT COURT

SOUTHINGTON, CT

PROGRESS ISSUE:

02/10/2023


KEY PLAN:

SCALE: |0' |10' |20'

SEAL:

SHEET TITLE:


NOTES

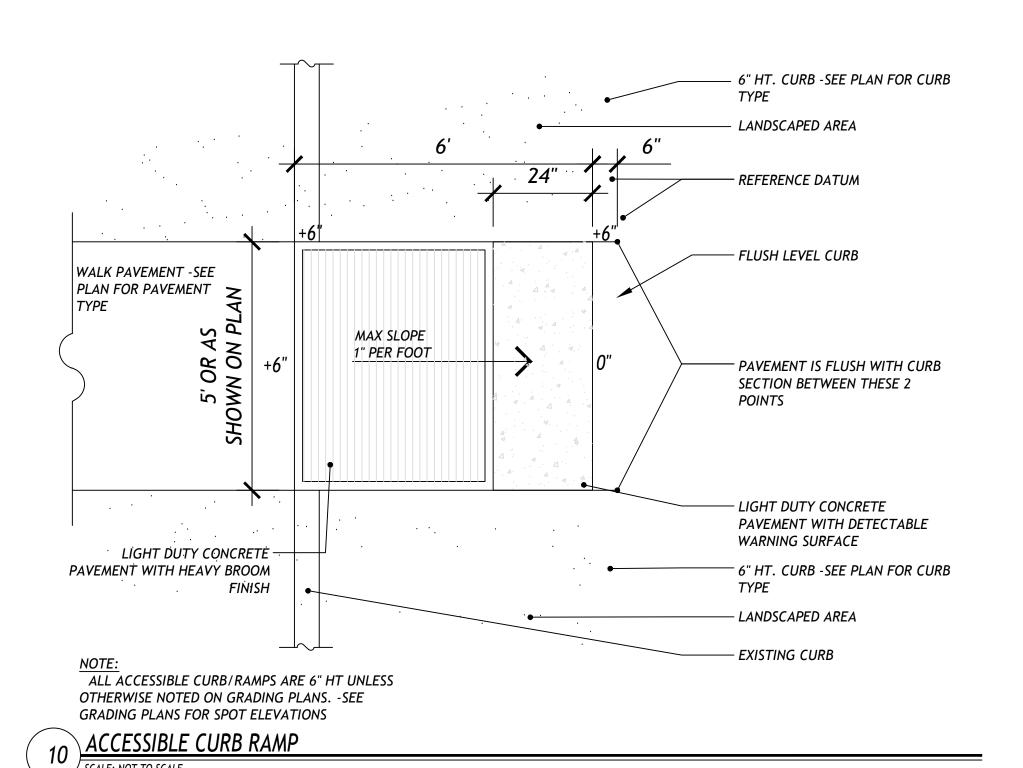


PAINT CONTACT SURFACE WITH —— CURING COMPOUND OR OTHER APPROVED BOND BREAKER BEFORE ADJACENT SLAB IS FORM KEY USING BEVELED WOOD -STRIP ATTACHED TO FORM. - SCORE LINE OVER BASE SLAB CONCRETE PAVEMENT — NOTE:
CONTRACTION JOINTS SHALL BE SPACED 10' O.C.

CONTRACTION JOINT SCALE: NOT TO SCALE


SCALE: NOT TO SCALE

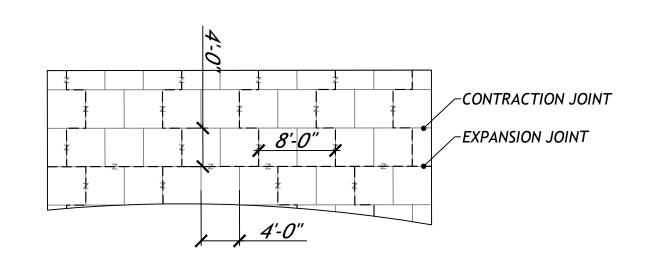


SCORE PATTERN FOR TERRACE SCALE: NOT TO SCALE

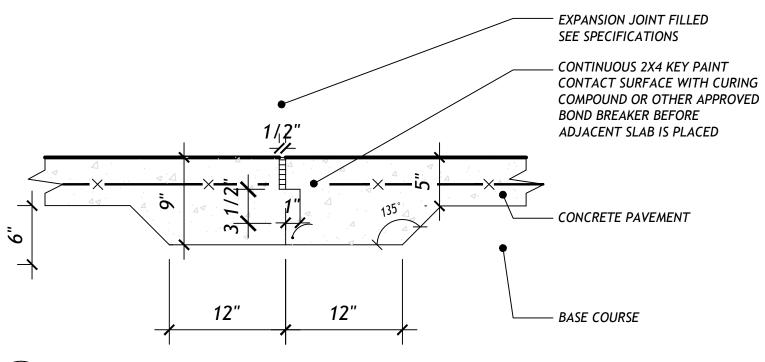


EXPANSION JOINT SCALE: NOT TO SCALE

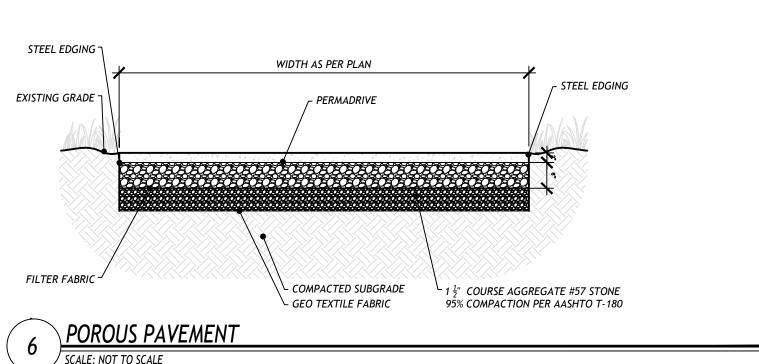


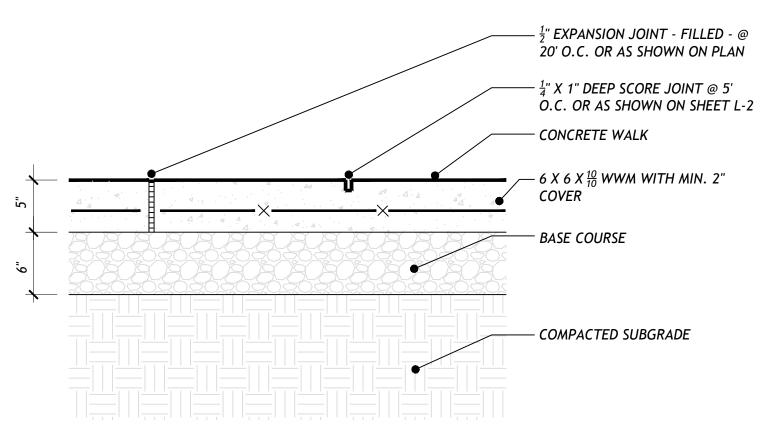


LIGHT DUTY CONCRETE PAVEMENT - SECTION SCALE: NOT TO SCALE

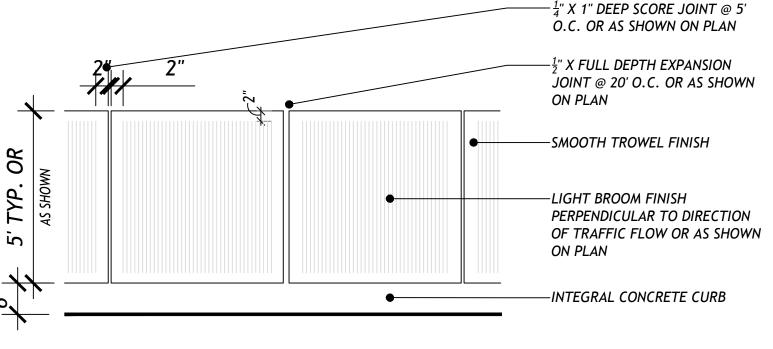


<u>LIGHT DUTY CONCRETE PAVEMENT - PLAN</u> SCALE: NOT TO SCALE

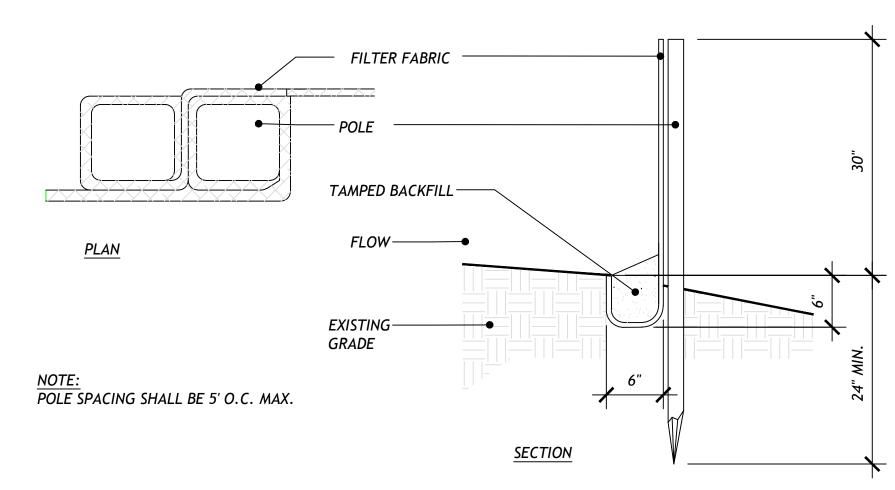

SILT FENCE SCALE: NOT TO SCALE

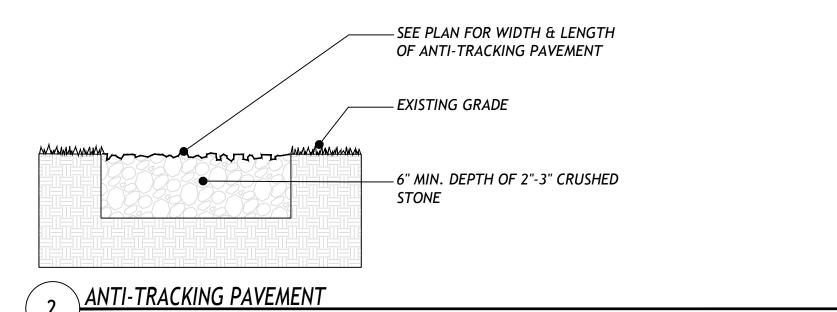

SCALE: NOT TO SCALE

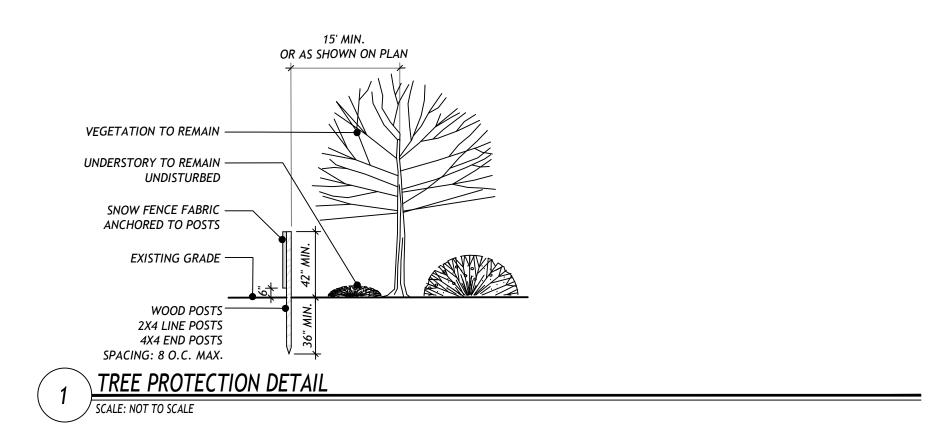

WILLIAM KENNY ASSOCIATES

LANDSCAPE ARCHITECTURE • ECOLOGICAL SERVICES

1899 Bronson Road Fairfield CT 06824 203 366 0588 www.wkassociates.net

PROJECT:

WESTON TOWN GREEN

OWNER / CLIENT:

WESTON BEAUTIFICATION COMMITTEE

> 56 NORFIELD ROAD WESTON, CT

DESIGN ARCHITECT:

THIEL ARCHITECTURE + DESIGN

1480 POST ROAD EAST 5A WESTPORT, CT

HORTICULTURAL DESIGNER:

KARIN'S GARDEN DESIGN

14 STONEHENGE ROAD WESTON, CT

MEMORIAL DESIGNER:

JULIE HANSELMANN DAVIES

57 PARK TERRACE EAST B27 NEW YORK, NY

ELECTRICAL ENGINEER:

SG ENGINEERING

56 FOXCROFT COURT SOUTHINGTON, CT

PROGRESS ISSUE: 1 ISSUED FOR BID

02/10/2023

KEY PLAN:

SCALE: AS NOTED


SEAL:

SHEET TITLE:


DETAILS

SHEET NUMBER:

D-1

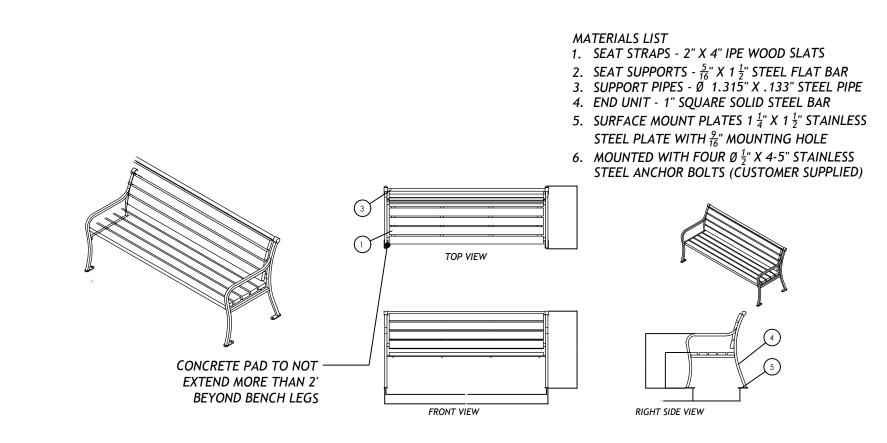



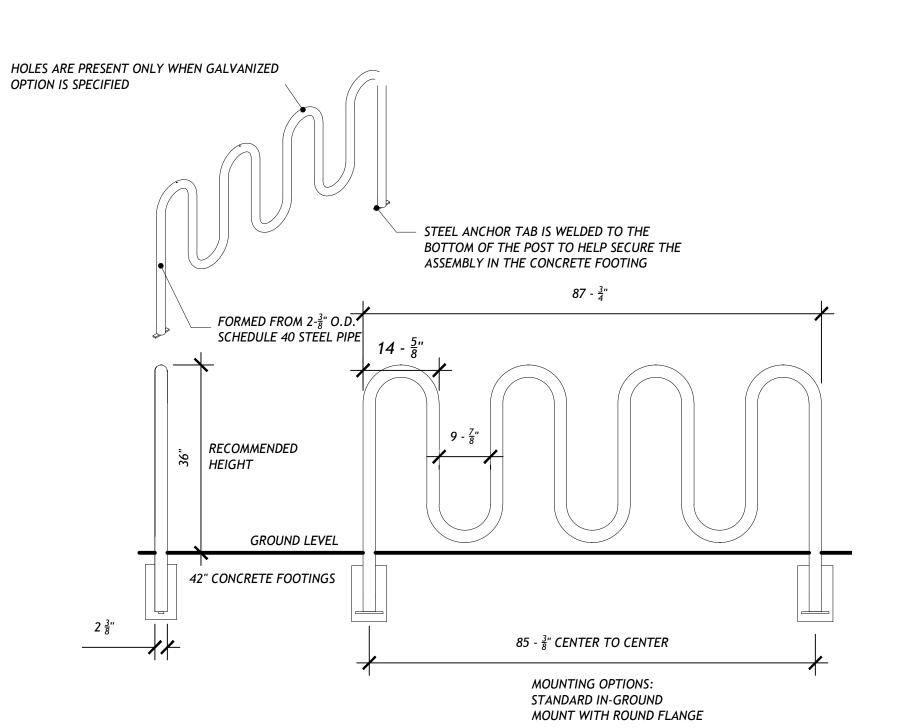

1. DRAWINGS NOT TO SCALE. DO NOT SCALE DRAWINGS.

- 2. ALL FABRICATED METAL COMPONENTS ARE STEEL SHOTBLASTED, ETCHED, PHOSPHATIZED, PREHEATED, AND ELECTROSTATICALLY POWDER-COATED WITH T.G.I.C. POLYESTER POWDER COATINGS. PRODUCTS ARE FULLY CLEANED AND PREHEATED, PREHEATED AND COATED WHILE HOT TO FILL CREVICES AND BUILD COATING FILM. COATED PARTS ARE THEN FULLY CURED TO COATING MANUFACTURER'S SPECIFICATIONS. THE THICKNESS OF THE RESULTING FINISH AVERAGES 8-10 MILS (200-250 MICRONS).
- 3. THIS SECURE SITE DESIGN, LLC. PRODUCT MUST BE PERMANENTLY AFFIXED IN THE GROUND.
- 4. COLOR: BLACK


BIKE RACK

SCALE: NOT TO SCALE

5. ALL SPECIFICATIONS ARE SUBJECT TO CHANGE.

TRASH RECEPTACLE SCALE: NOT TO SCALE

36 - GALLON SIDE DOOR OPENING LITTER RECEPTACLE WITH SIDE ACCESS SHOWN: STANDARD CONVEX BOLTED LID KEYED LOCK BOX

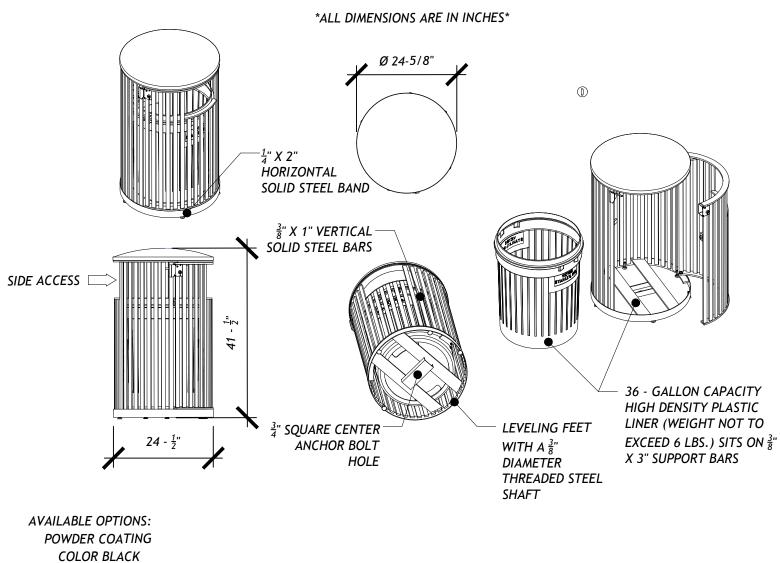

PRESSURE SENSITIVE VINYL OUTDOOR DECALS.


> 1. DRAWINGS NOT TO SCALE. DO NOT SCALE DRAWINGS. 2. ALL FABRICATED METAL COMPONENTS ARE STEEL SHOTBLASTED, ETCHED, PHOSPHATIZED, PREHEATED, AND ELECTROSTATICALLY POWDER-COATED WITH T.G.I.C. POLYESTER POWDER COATINGS. PRODUCTS ARE FULLY CLEANED AND PRETREATED, PREHEATED AND COATED WHILE HOT TO FILL CREVICES AND BUILD FILM COATING. COATED PARTS ARE THEN FULLY CURED TO COATING MANUFACTURER'S SPECIFICATIONS. THE THICKNESS OF THE RESULTING FINISH AVERAGES 8-10 MILS (200-250 MICRONS).

3. OIL IMPREGNATED BRONZE BUSHINGS AND STAINLESS STEEL PIVOT PINS FOR DOOR MOVEMENT, STANDARD 3/16" SOLID STEEL LATCH ASSEMBLY OR OPTIONAL PATENTED STAINLESS STEEL KEYED LOCK ASSEMBLY.

4. PRODUCT MUST BE PERMANENTLY AFFIXED TO THE GROUND. CONSULT YOUR LOCAL CODES FOR REGULATIONS. 5. PLASTIC INNER LINERS ARE MOLDED ON TOOLING DESIGNED FOR AND OWNED BY VICTOR STANLEY, INC. THEY OFFER MAXIMUM CAPACITY AND STRENGTH WITH LIGHTWEIGHT CONSTRUCTION USING CRITICAL MOLDED RIBS, INTEGRAL HANDHOLDS, AND HIGH-STRENGTH MATERIALS. THIS MINIMIZES HANDLING DIFFICULTY AND FACILITATES EASY EMPTYING AND STORAGE WHILE AFFORDING LONG SERVICE LIFE.

6. ALL SPECIFICATIONS ARE SUBJECT TO CHANGE. CONTACT MANUFACTURER FOR DETAILS.

REMOVE ALL NON-BIODEGRADEABLE WRAP. EXCAVATION AT BASE TO BE SAME AS ROOTBALL DIAMETER. TOP OF PIT TO BE AT LEAST 3X THE WIDTH OF THE ROOTBALL. BACKFILL WITH EXCAVATED MATERIAL. - UNDISTURBED SUBGRADE EVERGREEN TREE PLANTING DETAIL

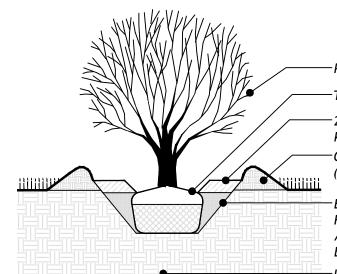

TREE PLANTING DETAIL

SCALE: NOT TO SCALE

-PRUNE AS DIRECTED BY L.A. TOP OF ROOTBALL 1"-2" ABOVE GRADE. -2" SHREDDED BARK MULCH. KEEP OFF TOP OF ROOTBALL. -CREATE SOIL SAUCER WITH TOPSOIL (6") MINIMUM. EXCAVATION AT BASE TO BE SAME AS ROOTBALL DIAMETER. TOP OF PIT TO BE

-STAKE & BRACE TREE IF DIRECTED BY L.A.

TOP OF ROOTBALL 1"-2" ABOVE GRADE. -EXCAVATION AT BASE TO BE SAME AS

BACKFILL WITH EXCAVATED MATERIAL.

ROOTBALL DIAMETER. TOP OF PIT TO BE AT LEAST 3X THE WIDTH OF THE ROOTBALL.

←2" SHREDDED BARK MULCH. KEEP OFF TOP OF

—FOLD DOWN OR CUT & REMOVE BURLAP AND WIRE BASKET FROM SIDE OF ROOTBALL. REMOVE ALL NON-BIODEGRADEABLE WRAP.

-CREATE SOIL SAUCER WITH TOPSOIL (6") MINIMUM.

- STAKE & BRACE TREE IF DIRECTED BY L.A.

TOP OF ROOTBALL 1"-2" ABOVE GRADE.

- 2" SHREDDED BARK MULCH. KEEP OFF TOP

- CREATE SOIL SAUCER WITH TOPSOIL (6") MIN.

FOLD DOWN OR CUT & REMOVE BURLAP AND

WIRE BASKET FROM SIDE OF ROOTBALL.

- PRUNE AS DIRECTED BY L.A.

OF ROOTBALL.

-PRUNE AS DIRECTED BY L.A.


-REMOVE TREE WRAP

ROOTBALL.

-UNDISTURBED SUBGRADE

AT LEAST 3X THE WIDTH OF THE ROOTBALL. BACKFILL WITH EXCAVATED MATERIAL. ---UNDISTURBED SUBGRADE

SHRUB PLANTING DETAIL

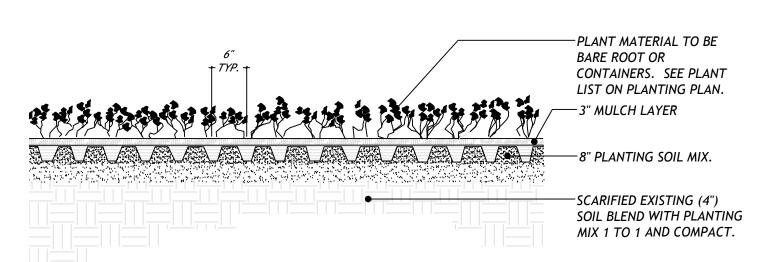

GROUNDCOVER PLANTING DETAIL SCALE: NOT TO SCALE

WILLIAM KENNY ASSOCIATES

LANDSCAPE ARCHITECTURE • ECOLOGICAL SERVICES 1899 Bronson Road Fairfield CT 06824

PROJECT:

WESTON TOWN GREEN

203 366 0588 www.wkassociates.net

OWNER / CLIENT:

WESTON BEAUTIFICATION COMMITTEE

> 56 NORFIELD ROAD WESTON, CT

DESIGN ARCHITECT:

THIEL ARCHITECTURE + DESIGN

1480 POST ROAD EAST 5A WESTPORT, CT

HORTICULTURAL DESIGNER:

KARIN'S GARDEN DESIGN

14 STONEHENGE ROAD WESTON, CT

MEMORIAL DESIGNER:

JULIE HANSELMANN DAVIES

57 PARK TERRACE EAST B27 NEW YORK, NY

ELECTRICAL ENGINEER:

SG ENGINEERING

56 FOXCROFT COURT SOUTHINGTON, CT

PROGRESS ISSUE:

1 ISSUED FOR BID

02/10/2023

KEY PLAN:


SCALE: AS NOTED


SEAL:

SHEET TITLE:

DETAILS

SHEET NUMBER:

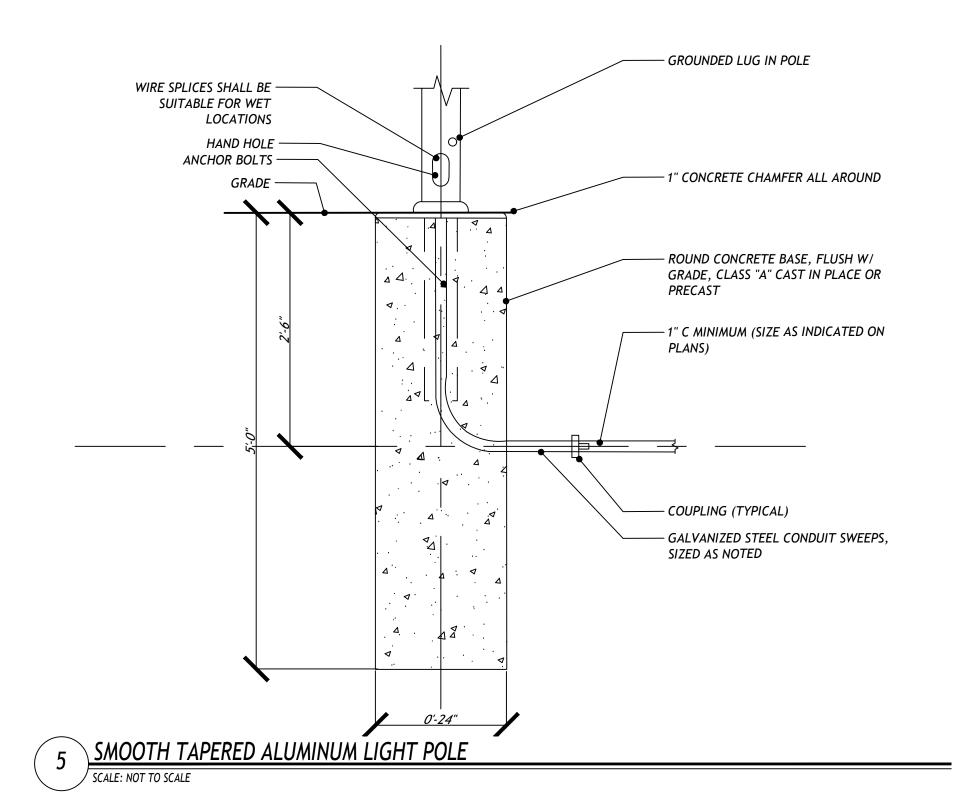

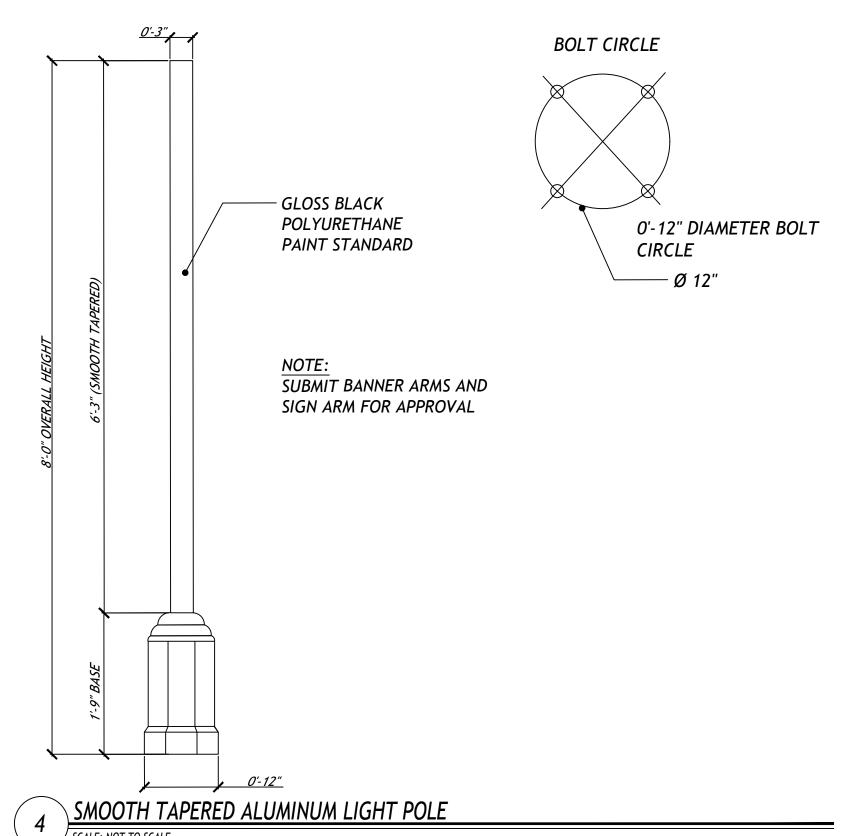

LANDSCAPE BOULDER - SEE


- ANGULAR SAND SETTING BED, WRAPPED

- 4" COMPACTED AGGREGATE BASE.

SPECIFICATIONS.

– FINISHED GRADE

SEE SPECIFICATIONS

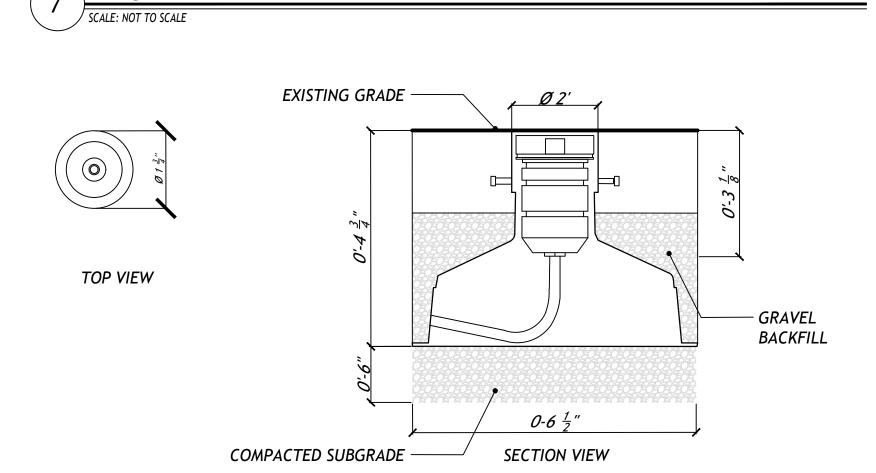

_ PEA GRAVEL - FINISH GRADE

- GRAVEL SUBBASE

- COMPACTED SUBGRADE

6 IN GROUND LIGHT FIXTURES

SCALE: NOT TO SCALE

PEA GRAVEL

JAGGED EDGES SHALL BE GROUND SMOOTH WHEN DIRECTED BY LANDSCAPE ARCHITECT 2. LAYOUT OF BOULDERS SHALL BE APPROVED BY LANDSCAPE ARCHITECT.

1. BOULDERS SHALL BE INSTALLED SO THAT NO ROCKING WILL OCCUR. ANY ROUGH OR

3 LANDSCAPE BOULDER
SCALE: NOT TO SCALE

ACCESSIBLE PARKING SIGN - SEE LAYOUT DRAWINGS FOR SIGN TYPE

4° LINE (TYP.)

4° LINE (TYP.)


—3" BLUE LINE
- INTERNATIONAL SYMBOL OF
ACCESSIBILITY. TYPICAL ALL
HANDICAPPED SPACES

2 ACCESSIBLE PARKING SPACE

10'

ACCESSIBLE PARKING SPACE

SCALE: NOT TO SCALE

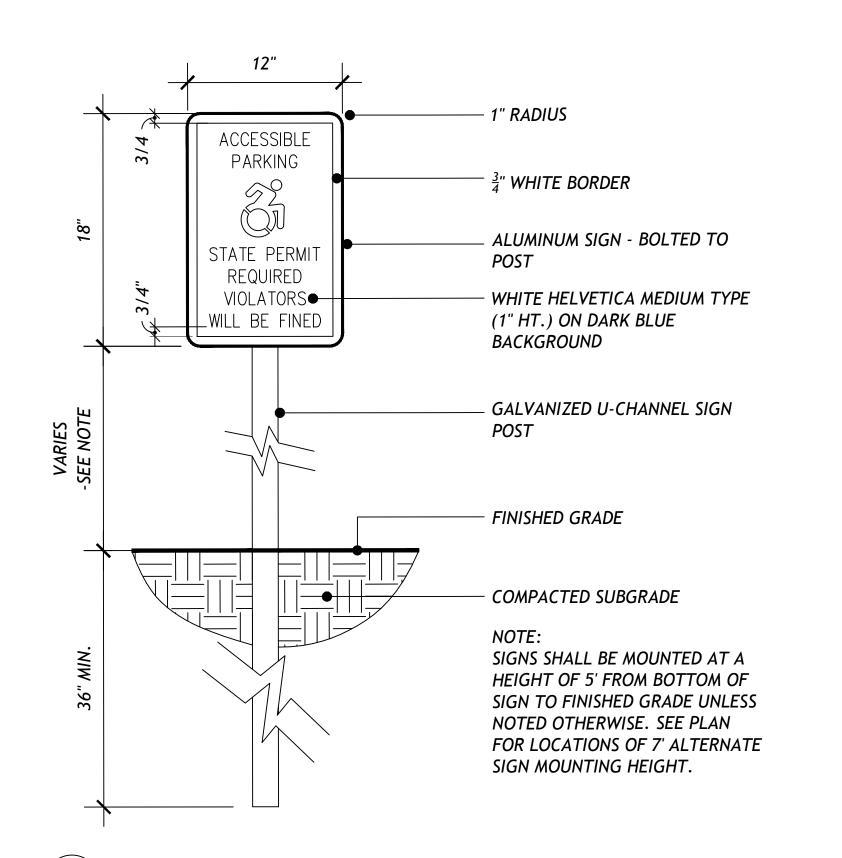

ACCESSIBLE PARKING SIGN
SCALE: NOT TO SCALE

WILLIAM KENNY ASSOCIATES

LANDSCAPE ARCHITECTURE • ECOLOGICAL SERVICES

1899 Bronson Road Fairfield CT 06824

203 366 0588 www.wkassociates.net

PROJECT:

WESTON TOWN GREEN

OWNER / CLIENT:

WESTON BEAUTIFICATION COMMITTEE

56 NORFIELD ROAD WESTON, CT

DESIGN ARCHITECT:

THIEL ARCHITECTURE + DESIGN

1480 POST ROAD EAST 5A WESTPORT, CT

HORTICULTURAL DESIGNER:

KARIN'S GARDEN DESIGN

14 STONEHENGE ROAD WESTON, CT

MEMORIAL DESIGNER:

JULIE HANSELMANN DAVIES

57 PARK TERRACE EAST B27 NEW YORK, NY

ELECTRICAL ENGINEER:

SG ENGINEERING

56 FOXCROFT COURT SOUTHINGTON, CT

PROGRESS ISSUE:

1 ISSUED FOR BID

02/10/2023

KEY PLAN:

SCALE: AS NOTED

SEAL:

SHEET TITLE:


DETAILS

SHEET NUMBER:


D-3

MEMORIAL NOTES


- 1. THE EXISTING WORLD WAR 1 BOULDER AND PLAQUE TO BE RELOCATED TO THE NEW LOCATION.
- 2. THE EXISTING VIETNAM AND PERSIAN GULF MEMORIAL PLAQUES SHALL BE REMOVED FROM THE EXISTING BOULDER AND REUSED. THE EXISTING BOULDER MAY BE USED FOR THE DEDICATION MARKER IF DAMAGE FROM REMOVING THE PLAQUES IS MINIMAL OR CAN BE FABRICATED TO REMOVE BLEMISHES AND IS APPROVED BY THE TOWN OF WESTON. BOTH EXISTING BOULDERS SHOULD BE TAKEN TO MONUMENT SUB, FOR CLEANING AND OR DRESSING.
- 3. THE TOWN HAS IDENTIFIED BOULDERS WITHIN THE TOWN LIMITS THAT MEET THE SIZE CRITERIA FOR THE REMAINING MEMORIAL BOULDERS. THE CONTRACTOR SHALL PICK UP OR EXTRACT THE BOULDERS AS REQUIRED AND DELIVER THEM TO THE MONUMENT FABRICATOR AND BRING THEM BACK TO THE SITE FOR PLACEMENT. SUGGESTED MONUMENT FABRICATORS:
- 3.1. ARTISTA STUDIOS & MONUMENT WORK, 500 BOSTON AVENUE, BRIDGEPORT CT 06605 PHONE: 203-333-9224
- 3.2. BROWN'S MONUMENT WORKS, 412 MAIN STREET, MONROE, CT 06468 PHONE: 203-268-9409
- 3.3. OR AN APPROVED MONUMENT STUDIO SELECTED BY THE CONTRACTOR.
- 4. PLACEMENT OF THE BOULDERS SHALL BE OVERSEEN AND APPROVED BY THE MEMORIAL DESIGNER.

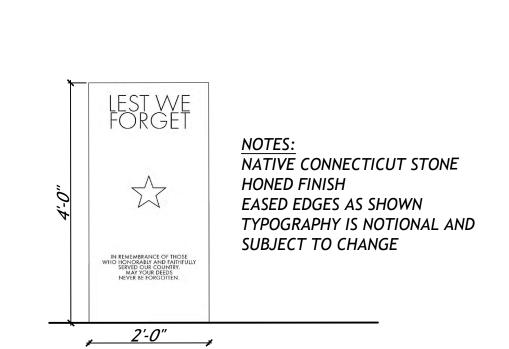




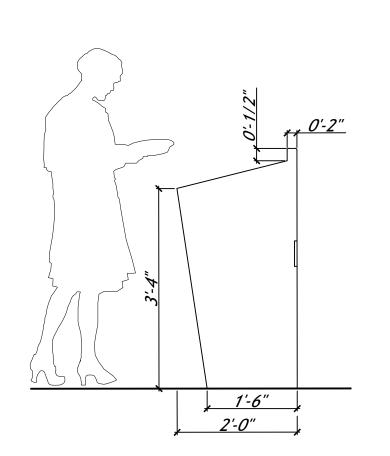

3 DEDICATION MARKER SECTION

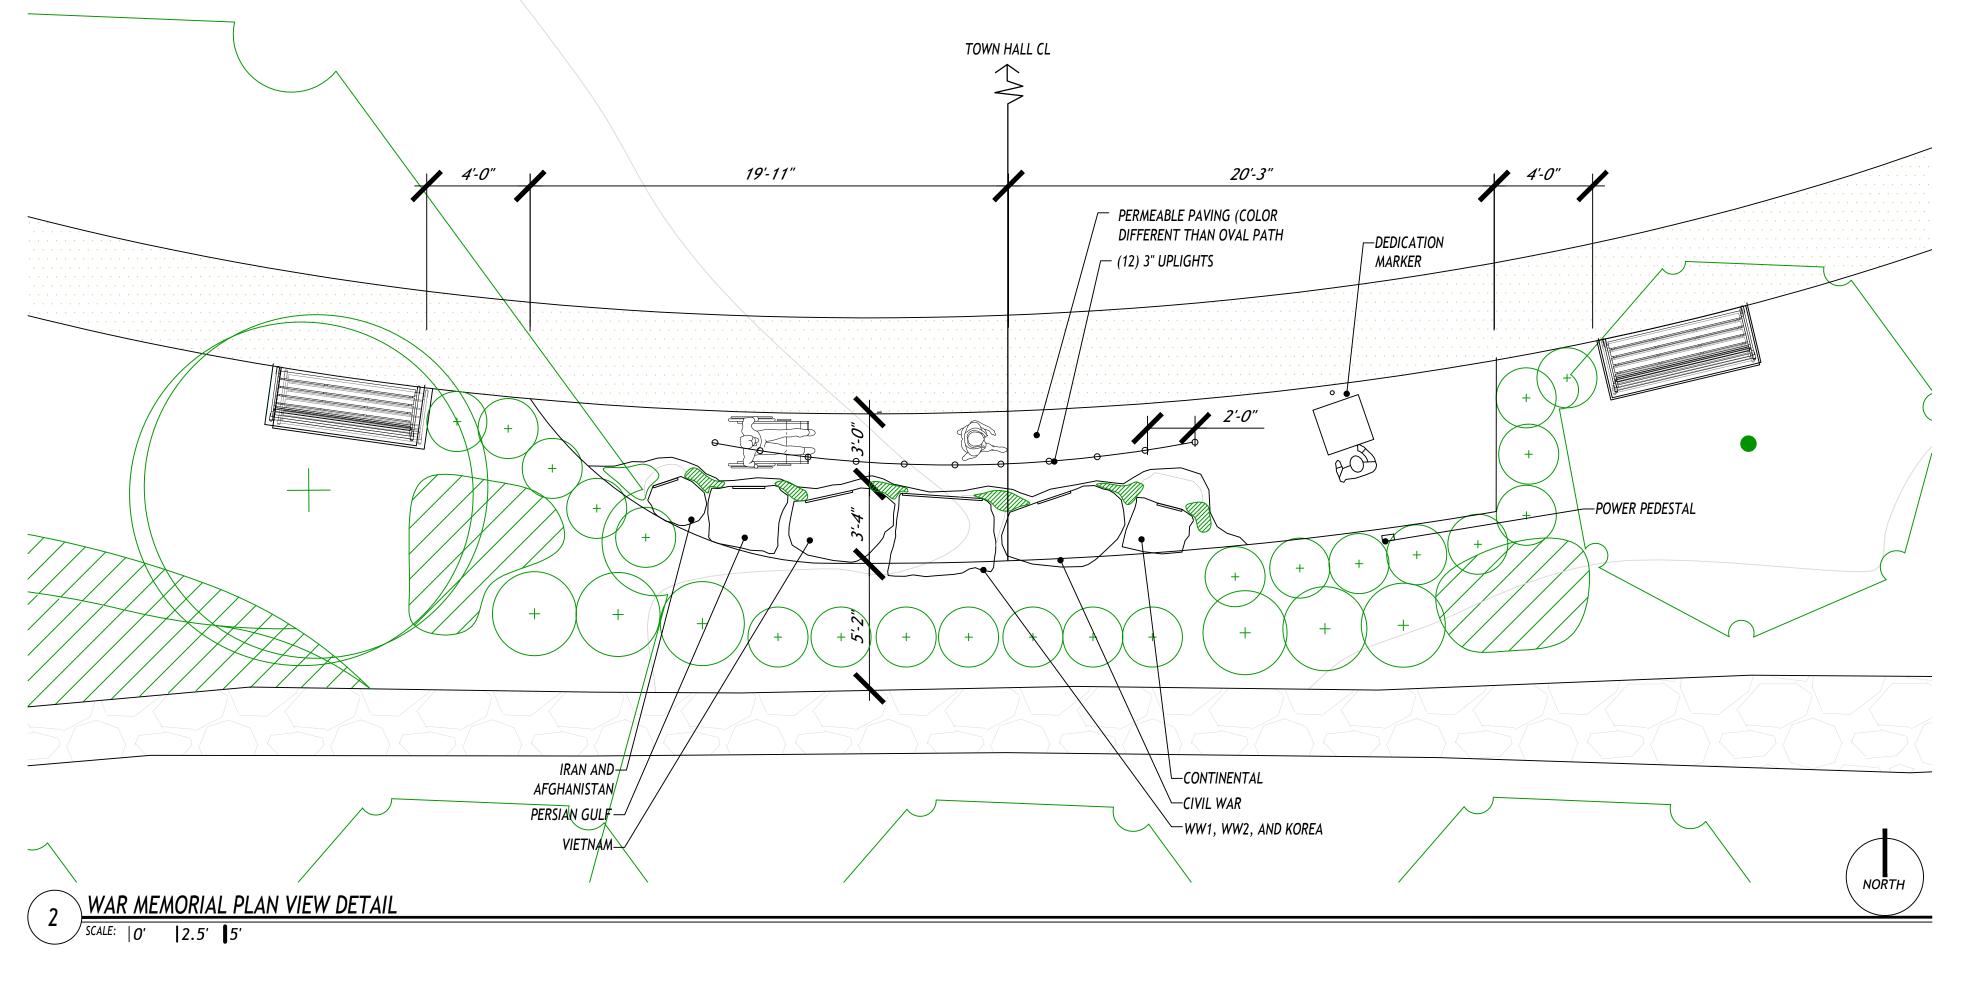

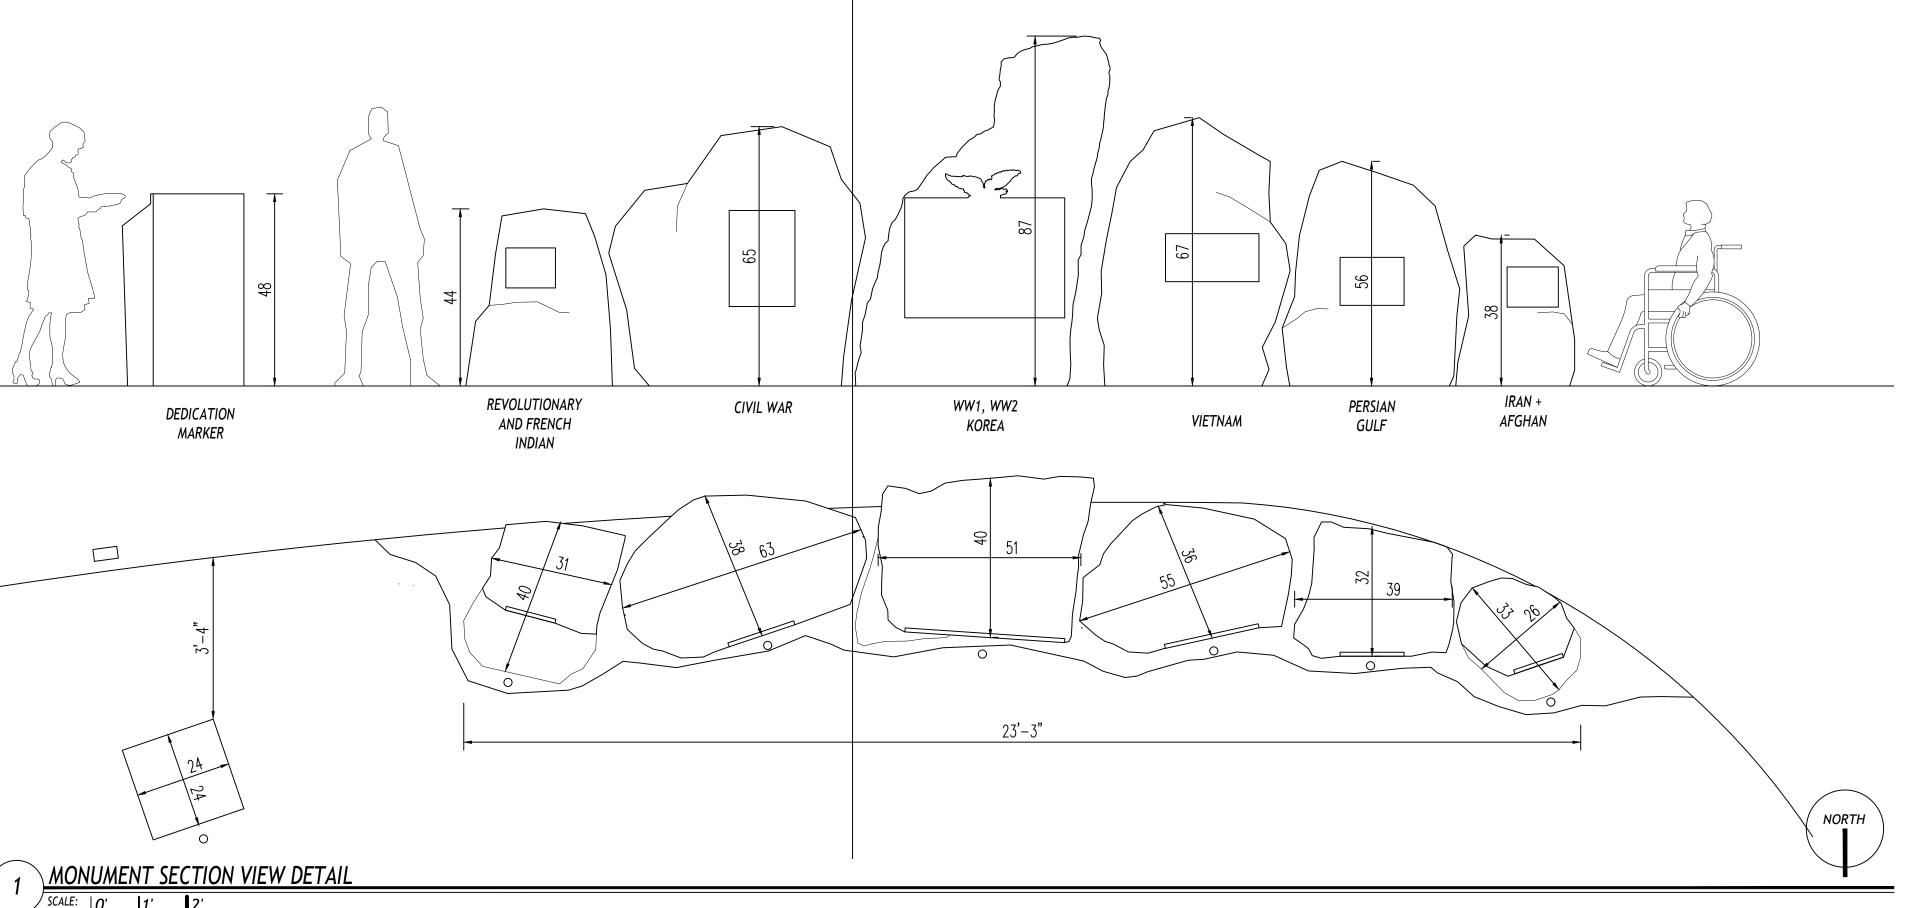

WILLIAM KENNY ASSOCIATES

LANDSCAPE ARCHITECTURE

ECOLOGICAL SERVICES

1899 Bronson Road Fairfield CT 06824 203 366 0588 www.wkassociates.net

PROJECT:

WESTON TOWN GREEN

OWNER / CLIENT:

WESTON BEAUTIFICATION COMMITTEE

56 NORFIELD ROAD WESTON, CT

DESIGN ARCHITECT:

THIEL ARCHITECTURE + DESIGN

1480 POST ROAD EAST 5A WESTPORT, CT

HORTICULTURAL DESIGNER:

KARIN'S GARDEN DESIGN

14 STONEHENGE ROAD WESTON, CT

MEMORIAL DESIGNER:

JULIE HANSELMANN DAVIES

57 PARK TERRACE EAST B27 NEW YORK, NY

ELECTRICAL ENGINEER:

SG ENGINEERING

56 FOXCROFT COURT SOUTHINGTON, CT

PROGRESS ISSUE:

1 ISSUED FOR BID

02/10/2023

KEY PLAN:

SCALE: AS NOTED

SEAL:

SHEET TITLE:

WAR MEMORIAL DETAILS

SHEET NUMBER:

D-4

ELECTRICAL SPECIFICATIONS

PART 1 - GENERAL PROVISIONS FOR ELECTRICAL WORK

<u>REFERENCES</u>

THIS SECTION COVERS THE GENERAL REQUIREMENTS FOR ELECTRICAL WORK; EXAMINE ALL CONTRACT DRAWINGS AND ALL OTHER SECTIONS OF THE SPECIFICATIONS FOR ADDITIONAL WORK RELATED TO THE WORK OF THIS DIVISION.

'PROVIDE' - TO FURNISH, INSTALL AND CONNECT UP COMPLETE AND READY FOR SAFE THE FOLLOWING IS A LIST OF ELECTRICAL ITEMS THAT MUST BE SUBMITTED FOR AND REGULAR OPERATION OF PARTICULAR WORK REFERRED TO UNLESS, SPECIFICALLY OTHERWISE NOTED.

'INSTALL' - TO ERECT, MOUNT AND CONNECT COMPLETE WITH RELATED ACCESSORIES. b. LIGHTING FIXTURES & LIGHTING CONTROLS

OTHER ITEMS REQUIRED FOR PROPER AND COMPLETE INSTALLATION.

'WIRING' - RACEWAY, FITTINGS, WIRE, BOXES, MOUNTING HARDWARE AND RELATED

IN FURRED SPACES, WITHIN DOUBLE PARTITIONS OR HUNG CEILINGS.

'SIMILAR' OR 'EQUAL' - EQUAL MATERIALS, WEIGHT, SIZE, DESIGN AND EFFICIENCY OF SPECIFIED PRODUCT.

'CONTRACTOR' - THE ELECTRICAL CONTRACTOR.

'NOTED' - AS INDICATED ON THE DRAWINGS AND/OR SPECIFICATIONS.

THIS WORK SHALL CONSIST OF THE FURNISHINGS OF ALL LABOR, MATERIALS AND SERVICES REQUIRED COMPLETE, READY FOR CORRECT OPERATION FOR ALL ELECTRICAL WORK CALL FOR BY THE ACCOMPANYING DRAWINGS AND SPECIFICATIONS, ALL ELECTRICAL WORK SHALL BE PERFORMED IN ACCORDANCE WITH EQUIPMENT, ETC., INCLUDED IN THIS CONTRACT, THE CONTRACTOR WILL BE HELD THE NATIONAL ELECTRICAL CODE, STATE AND LOCAL CODES.

THE DATA INDICATED IN THESE DRAWINGS AND SPECIFICATIONS ARE AS EXACT AS COULD BE SECURED. BUT THEIR ABSOLUTE ACCURACY IS NOT GUARANTEED. DO NOT SCALE DRAWINGS. EXACT LOCATIONS, DISTANCES, LEVELS AND OTHER CONDITIONS GUIDANCE AND SECURE THE ENGINEER'S APPROVAL OF CHANGES IN LOCATIONS. CIRCUITS, WHERE SHOWN ON AN ELECTRICAL DRAWINGS, ARE SO INDICATED PRIMARILY FOR THE PURPOSE OF INDICATING THE GENERAL CIRCUIT PLAN AND DO NOT NECESSARILY INDICATE THE EXACT LOCATION OF ROUTING OF THE RACEWAYS UNLESS SPECIFICALLY INDICATED. CIRCUITS SHALL BE RUN IN SUITABLE CONDITIONS CONSIDERING STRUCTURAL FEATURES, OTHER TRADES, CONSTRUCTION METHODS AND GOOD INSTALLATION PRACTICE.

BEFORE SUBMITTING A BID, THE CONTRACTOR SHALL VISIT THE SITE AND BECOME THOROUGHLY FAMILIAR WITH ALL EXISTING CONDITIONS UNDER WHICH THE WORK AND WORK OF OTHER TRADES WILL BE INSTALLED. THIS CONTRACT INCLUDES ALL NECESSARY OFFSETS, TRANSITIONS, MODIFICATIONS AND RELOCATION REQUIRED TO INSTALL ALL NEW EQUIPMENT IN NEW OR EXISTING SPACES. CONTRACTOR SHALL INCLUDE ANY MODIFICATIONS REQUIRED IN EXISTING ELECTRICAL EQUIPMENT FOR INSTALLATION OF NEW ELECTRICAL EQUIPMENT AND NEW EQUIPMENT OF OTHER TRADES. (LIGHTING FIXTURES, DEVICES, CONDUIT WIRING, ETC.) ALL NEW AND EXISTING EQUIPMENT AND SYSTEMS SHALL BE FULLY OPERATIONAL UNDER THIS CONTRACT BEFORE THE PROJECT IS CONSIDERED COMPLETE. THE CONTRACTOR SHALL BE HELD RESPONSIBLE FOR ANY ASSUMPTIONS THAT ARE MADE, ANY OMISSIONS OR ERRORS MADE AS A RESULT OF FAILURE TO VISIT THE SITE AND BECOME THOROUGHLY FAMILIAR WITH THE EXISTING CONDITIONS AND THE CONTRACT DOCUMENTS OF ALL TRADES.

CODES, REGULATIONS AND STANDARDS

APPROVED CODES:

STATE DEMOLITION CODE STATE BUILDING CODE STATE FIRE SAFETY CODE

LOCAL BUILDING CODE **IBC - INTERNATIONAL BUILDING CODE** NFPA - NATIONAL FIRE PROTECTION CODE ANSI - AMERICAN NATIONAL STANDARDS INSTITUTE

ASTM - AMERICAN SOCIETY FOR TESTING AND MATERIALS OSHA - OCCUPATIONAL SAFETY AND HEALTH ADMINISTRATION U.L. - UNDERWRITERS LABORATORIES NFPA 70 - NATIONAL ELECTRICAL CODE

EPA - ENVIRONMENTAL PROTECTION AGENCY IEEE - INSTITUTE OF ELECTRICAL AND ELECTRONIC ENGINEERS NEMA - NATIONAL ELECTRICAL MANUFACTURERS ASSOCIATION IECC - INTERNATIONAL ENERGY CONSERVATION CODE ICC/ANSI A117.1 ACCESSIBLE AND USABLE BUILDINGS AND FACILITIES

PERMITS, FEES AND INSPECTIONS

THE CONTRACTOR SHALL GIVE ALL NECESSARY NOTICES, OBTAIN ALL PERMITS, PAY FOR ALL GOVERNMENT, STATE SALES TAXES AND APPLICABLE FEES. THE CONTRACTOR SHALL FILE ALL DRAWINGS, COMPLETE ALL DOCUMENTS AND OBTAIN ALL NECESSARY APPROVALS FROM THE PROPER AUTHORITY OR AGENCY HAVING JURISDICTION. OBTAIN ALL REQUIRED CERTIFICATES OF INSPECTION COVERING WORK. PLASTILINE. SCHEDULE 40 UNLESS OTHERWISE NOTED ON THE DRAWINGS. THE CONTRACTOR SHALL SEE THAT ALL REQUIRED INSPECTIONS AND TESTS ARE MADE AND SHALL COOPERATE TO MAKE THESE TESTS AS THOROUGH AND AS READILY FITTINGS MADE AS POSSIBLE. OWNER WILL PAY ANY UTILITY FEES.

MATERIALS AND WORKMANSHIP

ALL MATERIALS AND APPARATUS REQUIRED FOR THE WORK, EXCEPT AS OTHERWISE INSULATION BUSHINGS SHALL BE HIGH IMPACT THERMOPLASTIC PHENOLIC WITH 150 PROVIDE EXPANSION FITTINGS / SLIP FITTINGS WHERE CONDUITS EMERGE FROM SPECIFIED, SHALL BE NEW AND OF FIRST-CLASS QUALITY. IT SHALL BE FURNISHED, DELIVERED, ERECTED, CONNECTED, FINISHED IN EVERY DETAIL AND SO SELECTED AND ARRANGED AS TO FIT PROPERLY INTO THE BUILDING SPACES. WHERE NO SPECIFIC KIND OR QUALITY MATERIAL IS GIVEN, A FIRST-CLASS STANDARD ARTICLE AS MOLDED ON PHENOLIC INSULATION AND LAY-IN GROUNDING LUG. ACCEPTED BY THE ENGINEER SHALL BE FURNISHED.

ALL EQUIPMENT AND MATERIALS SHALL BE SPECIFICATION GRADE AND BEAR THE UNDERWRITER'S LABEL. NO SUBSTITUTE OR ALTERNATE EQUIPMENT, MATERIAL, ETC. WILL BE CONSIDERED FOR THIS PROJECT.

ALL WORK SHALL BE OF A QUALITY CONSISTENT WITH GOOD TRADE PRACTICE AND SHALL BE INSTALLED IN A NEAT, WORKMANLIKE MANNER. THE ENGINEER/OWNER RESERVES THE RIGHT TO REJECT ANY WORK WHICH. IN HIS OPINION, HAS BEEN INSTALLED IN A SUBSTANDARD, DANGEROUS OR IN A UNSERVICEABLE MANNER. THE CONTRACTOR SHALL REPLACE REJECTED WORK IN A SATISFACTORY MANNER AT NO EXTRA COST TO THE OWNER.

<u>GUARANTEES</u>

ALL WORKMANSHIP AND MATERIALS SHALL BE FULLY GUARANTEED FOR A PERIOD OF NUTS, CONDUIT SUPPORTS, 3/8" OR 1/2" THREADED RODS (SIZE REQUIRED FOR LOAD), THE INSULATION. CABLE PULLING LUBRICANT SHALL BE USED TO ASSIST IN PULLING. ONE YEAR AFTER ACCEPTANCE OF THE ENTIRE INSTALLATION COVERED BY THIS ETC. CONTRACT. SHOULD ANY DEFECTS OCCUR DURING THE GUARANTEED PERIOD, THE CONTRACTOR SHALL REPAIR AND/OR REPLACE ALL DEFECTIVE EQUIPMENT, MATERIAL CABLE TIES AND/OR WORK AT NO EXTRA CHARGE TO THE OWNER.

RECORD DRAWINGS

MAINTAIN, AT THE JOB SITE, A SET OF ELECTRICAL DRAWINGS INDICATING ALL CHANGES IN LOCATION OF THE EQUIPMENT, PANELS, DEVICES, ETC. FROM THE ORIGINAL LAYOUT. CLEARLY MARK IN RED ALL CHANGES ON THE DRAWINGS. AT THE COMPLETION OF THE PROJECT THE CONTRACTOR SHALL TURN OVER THE RECORD DRAWINGS TO THE ENGINEER/OWNER.

ALL WORK SHALL BE CARRIED OUT IN CONJUNCTION WITH OTHER TRADES AND FULL COOPERATION SHALL BE GIVEN IN ORDER THAT ALL WORK MAY PROCEED WITH A MINIMUM OF DELAY AND INTERFERENCE.

<u>SUBMITTALS</u>

SUBMIT ELECTRONIC COPIES FOR REVIEW, DETAILED SHOP DRAWINGS OF ALL EQUIPMENT AND MATERIAL SPECIFIED. THE CONTRACTOR SHALL REVIEW ALL SHOP DRAWINGS PRIOR TO SUBMISSION TO THE ENGINEER FOR REVIEW. NO MATERIAL OR EQUIPMENT MAY BE DELIVERED TO THE JOB SITE OR INSTALLED UNTIL CONTRACTOR HAS IN THEIR POSSESSION, APPROVED SHOP DRAWINGS FOR THE PARTICULAR MATERIAL OR EQUIPMENT. SHOP DRAWINGS SHALL BE SPECIFIC WITH ITEMS SUBMITTED FOR APPROVAL CLEARLY IDENTIFIED.

- a. CIRCUIT BREAKERS
- CONDUIT, WIRE AND CABLE
- 'WORK' LABOR, MATERIALS, EQUIPMENT, APPARATUS, CONTROLS, ACCESSORIES AND d. DEVICES (RECEPTACLES, SWITCHES, POWER PEDESTALS, ETC.)

WILL BE BOUND INTO OPERATING AND MAINTENANCE BOOKS.

OPERATING INSTRUCTIONS

THE CONTRACTOR SHALL FURNISH TO THE ENGINEER ELECTRONIC SETS OF TYPEWRITTEN OR BLUEPRINTED INSTRUCTIONS FOR OPERATING AND MAINTAINING 'CONCEALED' - EMBEDDED IN MASONRY OR OTHER CONSTRUCTION CAVITY, INSTALLED ALL SYSTEMS AND EQUIPMENT INCLUDED IN THIS DIVISION. MANUFACTURER'S ADVERTISING LITERATURE OR CATALOGS WILL NOT BE ACCEPTABLE FOR OPERATING AND MAINTENANCE INSTRUCTIONS.

> THE CONTRACTOR, IN THE ABOVE-MENTIONED INSTRUCTIONS, SHALL INCLUDE THE MAINTENANCE SCHEDULE FOR THE PRINCIPAL ITEMS OF EQUIPMENT FURNISHED

AN AUTHORIZED MANUFACTURER'S REPRESENTATIVE SHALL ATTEST IN WRITING THAT LIGHTING FIXTURES HIS EQUIPMENT HAS BEEN PROPERLY INSTALLED PRIOR TO STARTUP. THESE LETTERS

EQUIPMENT PROTECTION

PROPERLY AND COMPLETELY PROTECT AGAINST ALL DAMAGE, ALL APPARATUS. RESPONSIBLE FOR ANY DAMAGE TO FURNISHED APPARATUS, EQUIPMENT, ETC., UNTIL FINAL ACCEPTANCE.

WILL BE GOVERNED BY THE BUILDING. USE THE DRAWINGS AND SPECIFICATIONS FOR THE CONTRACTOR SHALL TAKE WHATEVER MEANS NECESSARY AND/OR REQUIRED TO CALCULATIONS SHALL BE PROVIDED FOR ALTERNATIVE FIXTURES TO DEMONSTRATE PROTECT OWNER'S PROPERTY WITHIN THE WORKING AREAS FROM DUST, DEBRIS AND EQUAL PERFORMANCE. OTHER MATTER GENERATED BY THE WORK. NO WORK SHALL COMMENCE IN AREAS WHERE PROTECTION IS REQUIRED UNTIL APPROVAL HAS BEEN GIVEN TO THE CONTRACTOR BY THE OWNER.

MANUFACTURER'S INSTRUCTION

INSTALL ALL EQUIPMENT IN ACCORDANCE WITH MANUFACTURER'S INSTRUCTIONS OR REQUIREMENTS FOR PROPER OPERATION AND MAINTENANCE.

EQUIPMENT PAINTING AND CLEANING

THOROUGHLY CLEAN ALL ELECTRICAL EQUIPMENT DEVICES AND ENCLOSURES UPON SERIES OR APPROVED EQUAL, WITH COLOR TO BE SELECTED BY THE OWNER. COMPLETION OF ALL WORK. REPAINT ANY EQUIPMENT WHOSE FINISH IS DAMAGED OR RUSTED. MATCH MANUFACTURER'S ORIGINAL FINISH.

PART 2 - PRODUCTS

DESCRIPTION

ALL MATERIALS AND EQUIPMENT PROVIDED UNDER THIS SECTION SHALL BE NEW, FIRST GRADE, BEST OF THEIR RESPECTIVE KINDS AND IN NO WAY SHALL THEY BE LESS THAN THE QUALITY AND INTENT SET FOURTH UNDER THIS SECTION. THEY SHALL MEET ALL CONDUIT AND WIRING SHALL BE INSTALLED CONCEALED UNLESS OTHERWISE THE REQUIREMENTS OF ALL STANDARDS SET UP TO GOVERN THE MANUFACTURER OF NOTED. ALL ELECTRICAL WORK SHALL BE PERFORMED IN ACCORDANCE WITH THE FOLLOWING ELECTRICAL MATERIALS AND COMPLY WITH ALL APPLICABLE CODES AND STANDARDS

CONDUCTORS SHALL BE U.L. LISTED, 600 VOLTS, 90 DEG, C., SINGLE CONDUCTOR TYPE COVERED WITH NYLON SHEATH JACKET. TESTED IN ACCORDANCE WITH THE REQUIREMENTS OF UNDERWRITERS LABORATORIES STANDARD 83. WIRE SHALL BE IDENTIFIED BY SURFACE MARKING INDICATING MANUFACTURER'S IDENTIFICATION CONDUCTOR SIZE AND METAL, VOLTAGE RATING, U.L. SYMBOL AND TYPE DESIGNATION. CONDUCTORS SHALL BE STRANDED. MINIMUM SIZE SHALL BE #12 AWG MINIMUM SIZE CONDUIT SHALL BE 3/4" UNLESS OTHERWISE NOTED. UNLESS OTHERWISE INDICATED. MANUFACTURED BY ROME CABLE, TRIANGLE WIRE & CABLE, GENERAL CABLE OR ESSEX WIRE & CABLE.

RIGID GALVANIZED STEEL CONDUIT (RGS)

RIGID STEEL CONDUIT SHALL BE FULL WEIGHT, HEAVY WALL STEEL PIPE WITH GALVANIZED PROTECTIVE COATING. MANUFACTURED BY TRIANGLE WIRE AND CABLE, RIGID GALVANIZED STEEL CONDUIT (RGS) SHALL BE USED FOR WIRING IN THE ALLIED TUBE AND CONDUIT, REPUBLIC OR STEELDUCT. CONDUIT FITTINGS SHALL BE FOLLOWING LOCATIONS: MALLEABLE IRON. CADMIUM PLATED WITH FULL THREADED HUBS.

RIGID POLYVINYL CHLORIDE CONDUIT (PVC)

RIGID POLYVINYL CHLORIDE CONDUIT SHALL BE TYPE DB. UNLIGHT RESISTANT. RATED OR USE WITH 90 DEGREES C. CONDUCTORS, U.L. RATED. ALL PVC CONDUIT AND FITTINGS SHALL BE SOLVENT WELDED. MANUFACTURED BY CARLON, ELECTRI-FLEX OR LOCATIONS:

CONDUIT BODIES FOR RIGID GALVANIZED STEEL CONDUIT (RGS) SHALL BE MALLEABLE IRON-ZINC PLATED WITH TAPERED HUBS AND GASKETED ALUMINUM COVER.

DEG. C. UL TEMPERATURE RATING. INSULATED GROUNDING BUSHINGS SHALL BE MALLEABLE IRON ZINC PLATED WITH

CONDUIT LOCKNUTS SHALL BE HEAVY NUT STOCK STEEL-ZINC PLATED. OFFSET NIPPLES SHALL BE MALLEABLE IRON ZINC PLATED WITH RIGID CONDUIT

CONDUIT STRAPS SHALL BE SNAP-TYPE, DOUBLE RIBBED STEEL-ZINC PLATED. CONDUIT FITTINGS SHALL BE MANUFACTURED BY O/Z GEDNEY, CROUSE-HINDS OR

THREADING AND 3/4" OFFSET.

SUPPORT CHANNEL SHALL BE ROLL-FORMED #12 GAUGE STEEL, SOLID BASE OR BOLT HOLE BASE - HOT DIP GALVANIZED FINISH. COMPLETE WITH ANGLE FITTINGS, SPRING EXERCISE CAUTION IN PULLING CONDUCTORS INTO RACEWAYS SO AS NOT TO DAMAGE

APPLETON.

CABLE TIES SHALL BE FABRICATED OF ONE-PIECE HALLAR WITH NO METAL PARTS MANUFACTURED BY BURNDY, T&B, PANDUIT OR BLACKBURN.

<u>HANDHOLES</u>

HANDHOLES SHALL BE OPEN BOTTOM, POLYMER CONCRETE, TIER 8, SIZE AS REQUIRED TO ACCOMMODATE ENTRY/EXIT LOCATIONS AND SIZES OF CONDUITS IN THE BOX. QUAZITE OR APPROVED EQUAL.

OUTLET BOXES

OUTLET BOXES SHALL BE WET LOCATION RATED, AND OF PROPER TYPE AND SIZE AS REQUIRED FOR THE PARTICULAR APPLICATION. SIZE AND TYPE DICTATED BY THE NUMBER OF DEVICES, NUMBER OF CONDUCTORS AND WIRING METHOD UTILIZED. BOXES SHALL BE ADEQUATE SIZE FOR THE INSTALLATION OF CONDUCTORS WITHOUT EXCESSIVE BENDING OR CRIMPING OF THE CONDUCTORS AND DAMAGING OF CONDUCTOR INSULATION. MANUFACTURED BY STEEL CITY OR RACO.

LIGHTING CONTROL SYSTEMS STARTUP & TRAINING

PROVIDE ON-SITE PROGRAMMING, STARTUP, CALIBRATION & OWNER'S TRAINING FOR THE LIGHTING CONTROL SYSTEM.

CIRCUIT BREAKERS

BRANCH CIRCUIT BREAKERS SHALL BE QUICK-MAKE, QUICK-BREAK, BOLT-IN THERMALMAGNETIC TYPE WITH VISIBLE CURRENT RATING AND TRIP POSITION. ENSURE COMPATIBILITY WITH PANELS IN WHICH THE BREAKERS ARE INSTALLED.

ALL MULTI-POLE BREAKERS SHALL BE EQUIPPED WITH HANDLE TIES FOR MULTI-POLE

ALL DEVICES (RECEPTACLES AND SWITCHES) SHALL BE COMMERCIAL SPECIFICATION GRADE, 20 AMP RATED, U.L. LISTED, SELF-GROUNDING, GROUND LUG, SIDE/BACK WIRED. MANUFACTURED BY HUBBELL, LEVITON, OR PASS & SEYMOUR.

FURNISH AND INSTALL ALL LIGHTING FIXTURES AS SPECIFIED ON THE SCHEDULES, COMPLETE WITH ALL ACCESSORIES, LOUVERS, LAMPS AND MOUNTING HARDWARE THE FIXTURES SHOWN ARE MARKED AS TYPE A, B, C, ETC.

CLEAN AND REMOVE ALL PAINT, STICKERS, DIRT, SMUDGES AND FINGERPRINTS FROM LIGHTING FIXTURES.

IF BASIS OF DESIGN FIXTURES ARE NOT PROVIDED, THE PROPOSED ALTERNATIVES SHALL BE EQUAL IN QUALITY, FEATURES, MATERIAL, COLOR/FINISH, APPEARANCE, DIMENSIONS AND PERFORMANCE. APPROVAL OF ANY PROPOSED ALTERNATIVES WILL OUTLET BOXES AND DEVICE BOXES. BE SUBJECT TO ENGINEER AND OWNER REVIEW. IN ADDITION, PHOTOMETRIC

BLACK FINISH WITH LOCKABLE HINGED COVER AND DEVICE TYPES AND QUANTITIES AS IDENTIFYING ALL BRANCH CIRCUITS. PROVIDE ADDITIONAL COPY OF COMPLETE INDICATED ON PLANS. LEGRAND XPP2G30C-BK OR EQUAL.

GROUND BOXES SHALL BE FLUSH WITH GRADE, WEATHERPROOF, WITH QUANTITY AND TYPE OF RECEPTACLES AS NOTED ON THE DRAWINGS. BOXES SHALL BE LEGRAND 'XB' WIRE MARKERS SHALL BE SECURELY ATTACHED AT BOTH ENDS, IDENTIFYING PANEL

PART 3 - EXECUTION

ALL WORK, MATERIALS AND MANNER OF INSTALLING SAME SHALL BE IN STRICT ACCORDANCE WITH THE LATEST REQUIREMENTS OF THE NATIONAL ELECTRIC CODE.

WIRING IN EXPOSED AREAS SHALL BE ROUTED IN RGS CONDUIT.

ENCLOSURES AND BOXES SHALL BE MECHANICALLY JOINED TO FORM A CONTINUOUS ELECTRICAL PATH.

THE CONTRACTOR SHALL PROVIDE APPROVED TYPE PULL BOXES AS REQUIRED.

FURNISH NYLON PULL STRINGS IN ALL EMPTY CONDUIT RUNS. FURNISH LOCKNUTS AND BUSHINGS FOR ALL CONDUIT TERMINATIONS IN ALL OUTLET

BOXES, PANELS, PULL BOXES, CONDUIT STUBS, ETC.

- 1. EXTERIOR EXPOSED INSTALLATIONS
- 2. CONDUIT SWEEPS / STUB-UPS 3. UNDER AREAS SUBJECT TO VEHICULAR TRAVEL

RIGID POLYVINYL CHLORIDE (PVC) SHALL BE USED FOR WIRING IN THE FOLLOWING

1. LIGHTING AND POWER BRANCH CIRCUIT OR FEEDER WIRING BURIED UNDER GRASS (SCHEDULE 40)

2. BELOW CONCRETE SLABS (SCHEDULE 40)

NEATLY ARRANGED AND TIED WITH CABLE TIES.

ALL CONDUIT SHALL BE SUPPORTED

UNDERGROUND AND CONNECT TO A RIGIDLY MOUNTED COMPONENT (E.G. PANELBOARD, JUNCTION BOX)

PROVIDE WIRING TO ALL OUTLETS, EQUIPMENT, APPARATUS AND OTHER SPECIALTIES UNDER THIS DIVISION THAT WHICH FURNISHED OR PROVIDED UNDER OTHER DIVISIONS OR BY THE OWNER.

THE TERM 'WIRING' SHALL BE CONSIDERED TO BE COMPRISED OF THE CONDUIT, CONDUCTORS, CONNECTIONS, ETC.

ALL WIRING ON DRAWINGS IS SIZED FOR TYPE THWN/THHN COPPER CONDUCTORS.

MINIMUM SIZE WIRE SHALL BE #12 UNLESS OTHERWISE INDICATED. ALL WIRING SHALL

CONDUCTORS WITHIN PANELBOARDS, JUNCTION BOXES, TROUGHS AND OTHER EQUIPMENT WHERE CONCENTRATIONS OF CONDUCTORS ARE ENCLOSED, SHALL BE

CIRCUITS SHALL BE SO CONNECTED TO THE PANELBOARDS THAT THE TOTAL LOAD IS DISTRIBUTED AS NEATLY AS POSSIBLE, EQUALLY BETWEEN EACH LINE AND NEUTRAL. 10% WILL BE CONSIDERED A REASONABLE AND ALLOWABLE UNBALANCE.

COMMON NEUTRAL FOR MULTIPLE BRANCH CIRCUITS IS NOT ACCEPTABLE. PROVIDE SEPARATE NEUTRAL FOR EACH BRANCH CIRCUIT.

WIRING IN OUTLET BOXES, JUNCTION BOXES, CABINET PANELBOARDS OR EQUIPMENT SHALL HAVE A MINIMUM OF EIGHT (8") INCHES LENGTH LEADS FOR CONNECTING WIRING DEVICES TO MAKE UP CIRCUIT SPLICES.

INSTALL COPPER GREEN INSULATED GROUNDING CONDUCTOR IN ALL CONDUITS AND

SPLICING SHALL BE DONE WITH INSULATED OR NON-INSULATED CONNECTORS OF APPROPRIATE TYPES AND CURRENT-CARRYING CAPACITY. NON-INSUALTED CONNECTORS SHALL BE WRAPPED WITH INSULATING TAPE TO THE THICKNESS OF THE INSULATION OF THE CONDUCTORS BEING SPLICED. ELECTRICAL TAPE SHALL BE 3M OR SUPER 88 SCOTCH VINYL FLAME-RETARDANT, COLD AND WEATHER RESISTANT.

SPLICES FOR CONDUCTORS, SIZES #10 AWG OR SMALLER SHALL BE MADE WITH U.L. LISTED SPRING-TYPE CONNECTORS OR APPROPRIATE CURRENT CARRYING CAPACITY.

SPLICES, TAPS AND TERMINALS FOR CONDUCTORS #8 AWG OR LARGER SHALL BE MADE WITH U.L. LISTED BOLTED PRESSURE CONNECTORS OF BRONZE OR COPPER CONSTRUCTION, OF APPROPRIATE CURRENT CARRYING CAPACITY. EQUAL TO O/Z GEDENY, BURNDY OR BLACKBURN.

CONDUCTOR IDENTIFICATION

CONDUCTORS #8 AWG AND SMALLER SHALL HAVE A COLOR-CODED INSULATION.

CONDUCTORS #6 AWG AND LARGER SHALL BE IDENTIFIED WITH TAPES APPLIED NEAR THE ENDS OF THE CONDUCTORS.

FEEDERS AND BRANCH CIRCUIT CONDUCTORS SHALL BE IDENTIFIED FOR PHASE

MATCH EXISTING CONDUCTOR COLORS TO EXISTING FACILITY WIRING.

ALL FEEDERS, MAINS AND BRANCH CIRCUIT CONDUCTORS SHALL BE TAGGED AT BOTH ENDS WITH WIRE MARKERS IN ALL PANELS, MOTOR CONTROLS, JUNCTION BOXES,

ITEMS BY NAME, FUNCTION AND/OR CONTROL. POWER PEDESTALS SHALL BE WEATHERPROOF, OUTDOOR RATED, 2-GANG CAPACITY, ALL PANELS SHALL BE PROVIDED WITH UPDATED TYPEWRITTEN CIRCUIT DIRECTORIES

FURNISH AND INSTALL NAMEPLATES FOR ALL ELECTRICAL EQUIPMENT, IDENTIFYING

USE PLASTIC-COATED WIRE MARKERS OF THE SELF-ADHESIVE. WRAPAROUND TYPE WITH PERMANENT FACTORY-PRINTED NUMBER, LETTERS AND SYMBOLS.

AND CIRCUIT BREAKER NUMBERS.

ALL CONDUCTORS SHALL BE PERMANENTLY TAGGED AT TIME OF INSTALLATION.

ALL ELECTRICAL WORK SHALL BE GROUNDED AND BONDED IN FULL CONFORMANCE WITH THE LATEST APPROVED EDITION OF THE NATIONAL ELECTRICAL CODE AND LOCAL REQUIREMENTS.

ALL ELECTRICAL EQUIPMENT, PANELBOARD ENCLOSURES, MOTOR FRAMES, SAFETY SWITCHES, METAL ENCLOSURES, ELECTRICAL DEVICE CLOSURES AND ALL OTHER EQUIPMENT SHALL BE MADE TO FORM A CONTINUOUS CONDUCTING, GROUND PATH OF LOW IMPEDANCE FOR GROUND FAULT CIRCUITS AND OPERATION OF THE CIRCUIT PROTECTIVE DEVICES WITHIN EACH CIRCUIT.

PROVIDE GROUNDING CONDUCTOR IN ALL RACEWAYS.

LABELS SHALL BE EQUAL TO T&B, PANDUIT OR IDEAL.

UPDATED PANEL DIRECTORY TO THE OWNER.

GROUND CONNECTIONS WITH THE GROUNDING CONDUCTORS SHALL BE MADE AT EACH OUTLET BOX. LIGHTING FIXTURE. MOTOR AND OTHER EQUIPMENT COMPONENTS BY MEANS OF A POSITIVELY SECURED GROUNDING CLAMP, SCREW OR CLIP.

BONDING SHALL BE PROVIDED TO ASSURE ELECTRICAL CONTINUITY AND THE CAPACITY TO SAFELY CONDUCT ANY FAULT CURRENT LIKELY TO BE IMPOSED.

ALL DEVICES (SWITCHES, RECEPTACLES, ETC.), SHALL BE GROUNDED TO CONDUIT SYSTEM WITH SIX (6") INCH SOLID COPPER #12 AWG INSULATED WIRE (GREEN) CONNECTED TO GROUND SCREW IN DEVICE AND FASTENED TO BACKBOX WITH 10-32x3/8" SLOTTED HEXAGON HEAD WASHER FACE GROUND WITH GREEN DYE FINISH.

END OF ELECTRICAL SPECIFICATIONS

WILLIAM KENNY ASSOCIATES

LANDSCAPE ARCHITECTURE • ECOLOGICAL SERVICES

1899 Bronson Road Fairfield CT 06824 203 366 0588 www.wkassociates.net

PROJECT:

WESTON TOWN GREEN

OWNER / CLIENT:

WESTON BEAUTIFICATION

56 NORFIELD ROAD

WESTON, CT



56 FOXCROFT COURT SOUTHINGTON, CT

PROGRESS ISSUE: 1 ISSUED FOR BID

ELECTRICAL ENGINEER:

02/10/2023

KEY PLAN:

SCALE: |0' |10' |20'

SHEET TITLE:

SHEET NUMBER:

LIGHT FIXTURE SCHEDULE					
TYPE	BASIS OF DESIGN	DESCRIPTION		LAMPING	REMARKS
SL1A	MAIN STREET LIGHTING 'ERIE' AA1708-4 (POLE) + BA-10 (SIGN BRACKETS) + SIGNAGE GENIE HOUSE 'ARABELLA' 82122 (RETROFITTED LED POST-TOP FIXTURE TO BE FURNISHED BY OWNER, MOUNT ON TOP OF NEW POLES)	POLE WITH EXISTING RETROFITTED LED FIXTURE HEAD, 8'-0" (OVERALL HEIGHT) SMOOTH TAPERED ALUMINUM SHAFT WITH 21"H DECORATIVE BASE, BLACK FINISH, TWO 18" BANNER ARMS MOUNTED AT 7' ABOVE GRADE. SECURE POLE TO A CONCRETE FOUNDATION. INSTALL RETROFITTED FIXTURES (FURNISHED BY THE OWNER) ON THE NEW POLE. REFER TO WK ASSOCIATES DRAWINGS FOR SIGNAGE TO BE PROVIDED ON THE POLES.	120V	18W LED (RETROFIT OF EXISTING FIXTURE)	1, 2, 3
SL1B	MAIN STREET LIGHTING 'ERIE' AA1708-4 + INTEGRAL OUTLET (POLE) GENIE HOUSE 'ARABELLA' 82122 (RETROFITTED LED POST-TOP FIXTURE TO BE FURNISHED BY OWNER, MOUNT ON TOP OF NEW POLES)	SAME AS TYPE 'SL1A', BUT WITH CONVENIENCE OUTLET INTEGRAL TO POLE AND NO SIGN BRACKET. MOUNT OUTLET DIRECTLY ABOVE BASE.	120V	18W LED (RETROFIT OF EXISTING FIXTURE)	1, 2, 3
SL2	iGUZZINI NORTH AMERICA ILUF50-MO-827-SH-REM-13 (FIXTURE) 4450-0500-027-UNV-ED10 (REMOTE DRIVER) IX490-XX (IN-GRADE BACK BOX) 9015-9016-KIT (CONNECTORS)	2" FLUSH MOUNTED IN-GRADE LIGHT FOR SIGNS, PROVIDE REMOTE OUTDOOR RATED DRIVER(S) IN ENCLOSURE ADJACENT TO FIXTURES, PROVIDE MOUNTING ACCESSORIES AND CONNECTORS AS REQUIRED, MEDIUM OUTPUT, 2700°K, SPOT COMFORT OPTIC, STAINLESS STEEL FINISH	120V (TO DRIVER)	1.4W LED	1, 2
SL3	iGUZZINI NORTH AMERICA ILUO80-MO-830-WL-REM-13 (FIXTURE) 4549-0500-027-UNV-ED10 (REMOTE DRIVER) X195-02-9583 (IN-GRADE BACK BOX) 9015-9016-KIT (CONNECTORS)	3" FLUSH MOUNTED IN-GRADE LIGHT FOR MEMORIAL, PROVIDE REMOTE OUTDOOR RATED DRIVERS IN ENCLOSURE ADJACENT TO FIXTURES (UP TO 5 FIXTURES PER DRIVER), PROVIDE MOUNTING ACCESSORIES AND CONNECTORS AS REQUIRED, MEDIUM OUTPUT, 3000°K, WALL WASHER OPTIC, STAINLESS STEEL FINISH	120V (TO DRIVER)	4.5W LED	1, 2

1. PROVIDE ALL NECESSARY MOUNTING HARDWARE, HANGERS, BRACKETS, ETC.

2. IF BASIS OF DESIGN FIXTURES ARE NOT PROVIDED, THE PROPOSED ALTERNATIVES SHALL BE EQUAL IN QUALITY, FEATURES, MATERIAL, COLOR/FINISH, DIMENSIONS, APPEARANCE AND PERFORMANCE APPROVAL OF ANY PROPOSED ALTERNATIVES WILL BE SUBJECT TO ENGINEER AND OWNER REVIEW. IN ADDITION, PHOTOMETRIC CALCULATIONS SHALL BE PROVIDED FOR ALTERNATIVE FIXTURES TO DEMONSTRATE EQUAL PERFORMANCE.

3. OWNER WILL RETROFIT EXISTING POST-TOP FIXTURES WITH LED LAMP SOURCE AND HAND OVER TO CONTRACTOR FOR INSTALLATION ON THE NEW POLES.

ELECTRICAL GENERAL NOTES

- UNLESS OTHERWISE INDICATED, FURNISH AND INSTALL A COMPLETE AND OPERATIONAL ELECTRICAL SYSTEM INCLUDING ALL NECESSARY MATERIAL, LABOR, AND EQUIPMENT.
- ELECTRICAL PLANS AND DETAILS, AND ONE LINE DIAGRAMS SHOW THE GENERAL LOCATION AND ARRANGEMENT OF THE ELECTRICAL SYSTEM. THEY ARE DIAGRAMMATIC AND DO NOT SHOW ALL CONDUIT BODIES, CONNECTORS, BENDS, FITTINGS, HANGERS, AND ADDITIONAL PULL AND JUNCTION BOXES WHICH THE CONTRACTOR MUST PROVIDE TO COMPLETE THE ELECTRICAL SYSTEM.
- . ALL EQUIPMENT AND MATERIAL SHALL BE LABELED AND LISTED, AND INSTALLED IN ACCORDANCE WITH THEIR LISTING.
- 4. THE CONTRACTOR SHALL OBTAIN ALL REQUIRED PERMITS AND ARRANGE FOR ALL REQUIRED INSPECTIONS IN ACCORDANCE WITH STATE GOVERNING AUTHORITIES.
- 5. ALL WORK SHALL BE DONE WITH LICENSED WORKERS IN ACCORDANCE WITH STATE GOVERNING
- 6. THE DEFINITION OF ELECTRICAL TERMS USED SHALL BE AS DEFINED IN THE NATIONAL ELECTRICAL
- . THE TERM "INDICATED" SHALL MEAN "AS SHOWN ON CONTRACT DOCUMENTS (SPECIFICATIONS,
- 8. THE TERM "SIZE" SHALL MEAN ONE OR MORE OF THE FOLLOWING: "LENGTH, CURRENT AND VOLTAGE RATING, NUMBER OF POLES, NEMA SIZE, AND OTHER SIMILAR ELECTRICAL CHARACTERISTICS".
- 9. THE TERM "SPACE" ON PANELBOARD AND SWITCHBOARD SCHEDULES SHALL MEAN "PROVIDE SPACE TO INSTALL THE NUMBER OF POLES AND SIZE OF THE PROTECTIVE DEVICE INDICATED WITH ALL THE
- 10. COORDINATE ELECTRICAL WORK WITH OWNER.

DRAWINGS, AND RELATED ATTACHMENTS)".

11. COORDINATE ELECTRICAL WORK WITH OTHER DIVISIONS OF THIS PROJECT.

NECESSARY BUS AND FITTINGS TO INSTALL THE DEVICE AT SOME FUTURE DATE".

- 12. BEFORE SELECTING MATERIAL AND EQUIPMENT, AND PROCEEDING WITH WORK, INSPECT AREAS WHERE MATERIAL AND EQUIPMENT ARE TO BE INSTALLED TO INSURE SUITABILITY, AND CHECK NEEDED SPACE FOR REPLACEMENT, CLEARANCES AND INTERCONNECTIONS.
- 13. ALL WORK SHALL BE DONE IN ACCORDANCE WITH THE NATIONAL ELECTRICAL CODE, 2020 EDITION.





EXISTING PANELBOARD 'MP-1' PHOTOS

SCALE: N.T.S.



PROVIDE NEW BREAKERS IN **EXISTING PANEL** 2#12, #12G, 1"C (LIGHTING SOURCE CIRCUIT) EXTERIOR PHOTOCELL MOUNTED PER MANUFACTURER'S INSTRUCTIONS 2-ZONE, NEMA 3R, ASTRONOMICAL TIMECLOCK WITH PHOTOCELL CONTROL (TORK OR EQUAL) 20A-1P TO CONTROL ZONE #1 LIGHT FIXTURES 20A-1P __ TO CONTROL ZONE #2 LIGHT FIXTURES - 2#12, #12G, 1"C SEE DRAWING E-2 FOR (CONTROL POWER) FIXTURE LOCATIONS AND CIRCUIT SIZING (6) ADDITIONAL 20A-1P BREAKERS EXISTING PANEL FOR RECEPTACLE CIRCUITS - SEE DRAWING E-2 FOR QUANTITIES 'MP-1' LOCATED ON BUILDING AND LOCATIONS **EXTERIOR** 208V, 1-PHASE 150A, NEMA 3R PARTIAL ELECTRICAL ONE-LINE DIAGRAM E-1 SCALE: N.T.S.

ABBREVIATIONS ABBREVIATIONS DESCRIPTION **AMPERES** AC ALTERNATING CURRENT (60 HZ) AIR CONDITIONING ADA AMERICANS WITH DISABILITIES ACT AFCI ARC FAULT CIRCUIT INTERRUPTER AFFV ABOVE FINISHED FLOOR ATS **AUTOMATIC TRANSFER SWITCH** AUX AUXILIARY AWG AMERICAN WIRE GAUGE BALLAST FACTOR BR BRANCH CONDUIT CB CIRCUIT BREAKER CIR CIRCUIT CLG CEILING MOUNTED CT CURRENT TRANSFORMER CU D COPPER DISHWASHER DISC DISCONNECT DW **DISHWASHER** DWG DRAWING DWU DISTILLED WATER UNIT EXISTING TO REMAIN EMT ELECTRICAL METALLIC TUBING **EQUIP EQUIPMENT** EXISTING EQUIPMENT TO REMAIN EX/ETR FDR FEEDER FL **FLOOR** FT FEET GROUND-FAULT CIRCUIT-INTERRUPTER GROUND-FAULT CIRCUIT EQUIPMENT BREAKER GROUND-FAULT PROTECTION GRD GROUND HEAT DETECTOR HD HAND-HOLE HP HORSEPOWER INSULATED GROUND IG IM ICE MAKER IMP IMPEDANCE INCHES JUNCTION KILO AMPERE KA THOUSAND CIRCUIT MILLS Kcmils ΚV KILOVOLT KW KILO VOLT-AMPERE KILOWATT LP LIGHTING PANELBOARD LTG LIGHTING METER MOTOR CONTROLLER MCB MAIN CIRCUIT BREAKER MCC/MCB MOLDED CASE CIRCUIT BREAKER MCS MOTOR-CIRCUIT SWITCH MAIN DISTRIBUTION PANELBOARD MDP MANHOLE MLO MAIN LUG ONLY MICROWAVE OVEN MW N/A NOT APPLICABLE NEC NATIONAL ELECTRIC CODE NECA NATIONAL ELECTRICAL CONTRACTORS ASSOC. NEMA NATIONAL ELECTRICAL MANUFACTURERS ASSOC. NEUT NEUTRAL NONFUSED NIC NOT IN CONTRACT NEW LOCATION OF RELOCATED ITEM N.T.S. NOT TO SCALE OVERCURRENT POLE PUBLIC ADDRESS PA PB PULL BOX PC PHOTO CELL PH PHASE PNL PANELBOARD PRI PRIMARY POUNDS PER SQUARE INCH PVC POLYVINYL CHLORIDE PWR POWER REMAIN REMOVE EXISTING ITEM RE RECPT RECEPTACLE RIGID GALVANIZED STEEL CONDUIT RGS RL RM RELOCATE EXISTING ITEM ROOM RNC RIGID NONMETALLIC CONDUIT REFRIGERATOR RSC RIGID STEEL CONDUIT S SC SMOKE DETECTOR SERVICE CONDUCTORS SCHD SCR SCHEDULE SHORT-CIRCUIT RATING SD SERVICE DROP SE SERVICE EQUIPMENT SEC SECONDARY STUNT TRIP

SURF

SV

SW

SYM

TEL

TV

TYP

U.O.N.

UTIL UVR

VA

W

WG

WP

WT

XFMR

UG

SYMB

SURFACE

SWITCH

SYMBOL

TYPICAL UNDERGROUND

UTILITY

VOLTS

WATTS

FEET **INCHES**

VOLT-AMPERES

WEIGHT IN POUNDS

WIRE GUARD

WATERTIGHT REMOVE

TRANSFORMER PERCENT NUMBER

SOLENOID VALVE

TIME CONTROLLER

UNDERWRITER'S LABORATORY

WALL PHONE OR WEATHERPROOF

UNLESS OTHERWISE NOTED

UNDER VOLTAGE RELEASE

SYMMETRICAL

TELEPHONE

TELEVISION

SCALE: |0' |10' |20'

SHEET TITLE:

ELECTRICAL SCHEDULES, NOTES AND ABBREVIATIONS

WILLIAM KENNY ASSOCIATES

LANDSCAPE ARCHITECTURE

ECOLOGICAL SERVICES

WESTON TOWN GREEN

WESTON BEAUTIFICATION

COMMITTEE

56 NORFIELD ROAD

WESTON, CT

56 FOXCROFT COURT

SOUTHINGTON, CT

02/10/2023

PROJECT:

OWNER / CLIENT:

ELECTRICAL ENGINEER:

PROGRESS ISSUE:


KEY PLAN:

1 ISSUED FOR BID

1899 Bronson Road Fairfield CT 06824 203 366 0588 www.wkassociates.net

SHEET NUMBER:

E-1

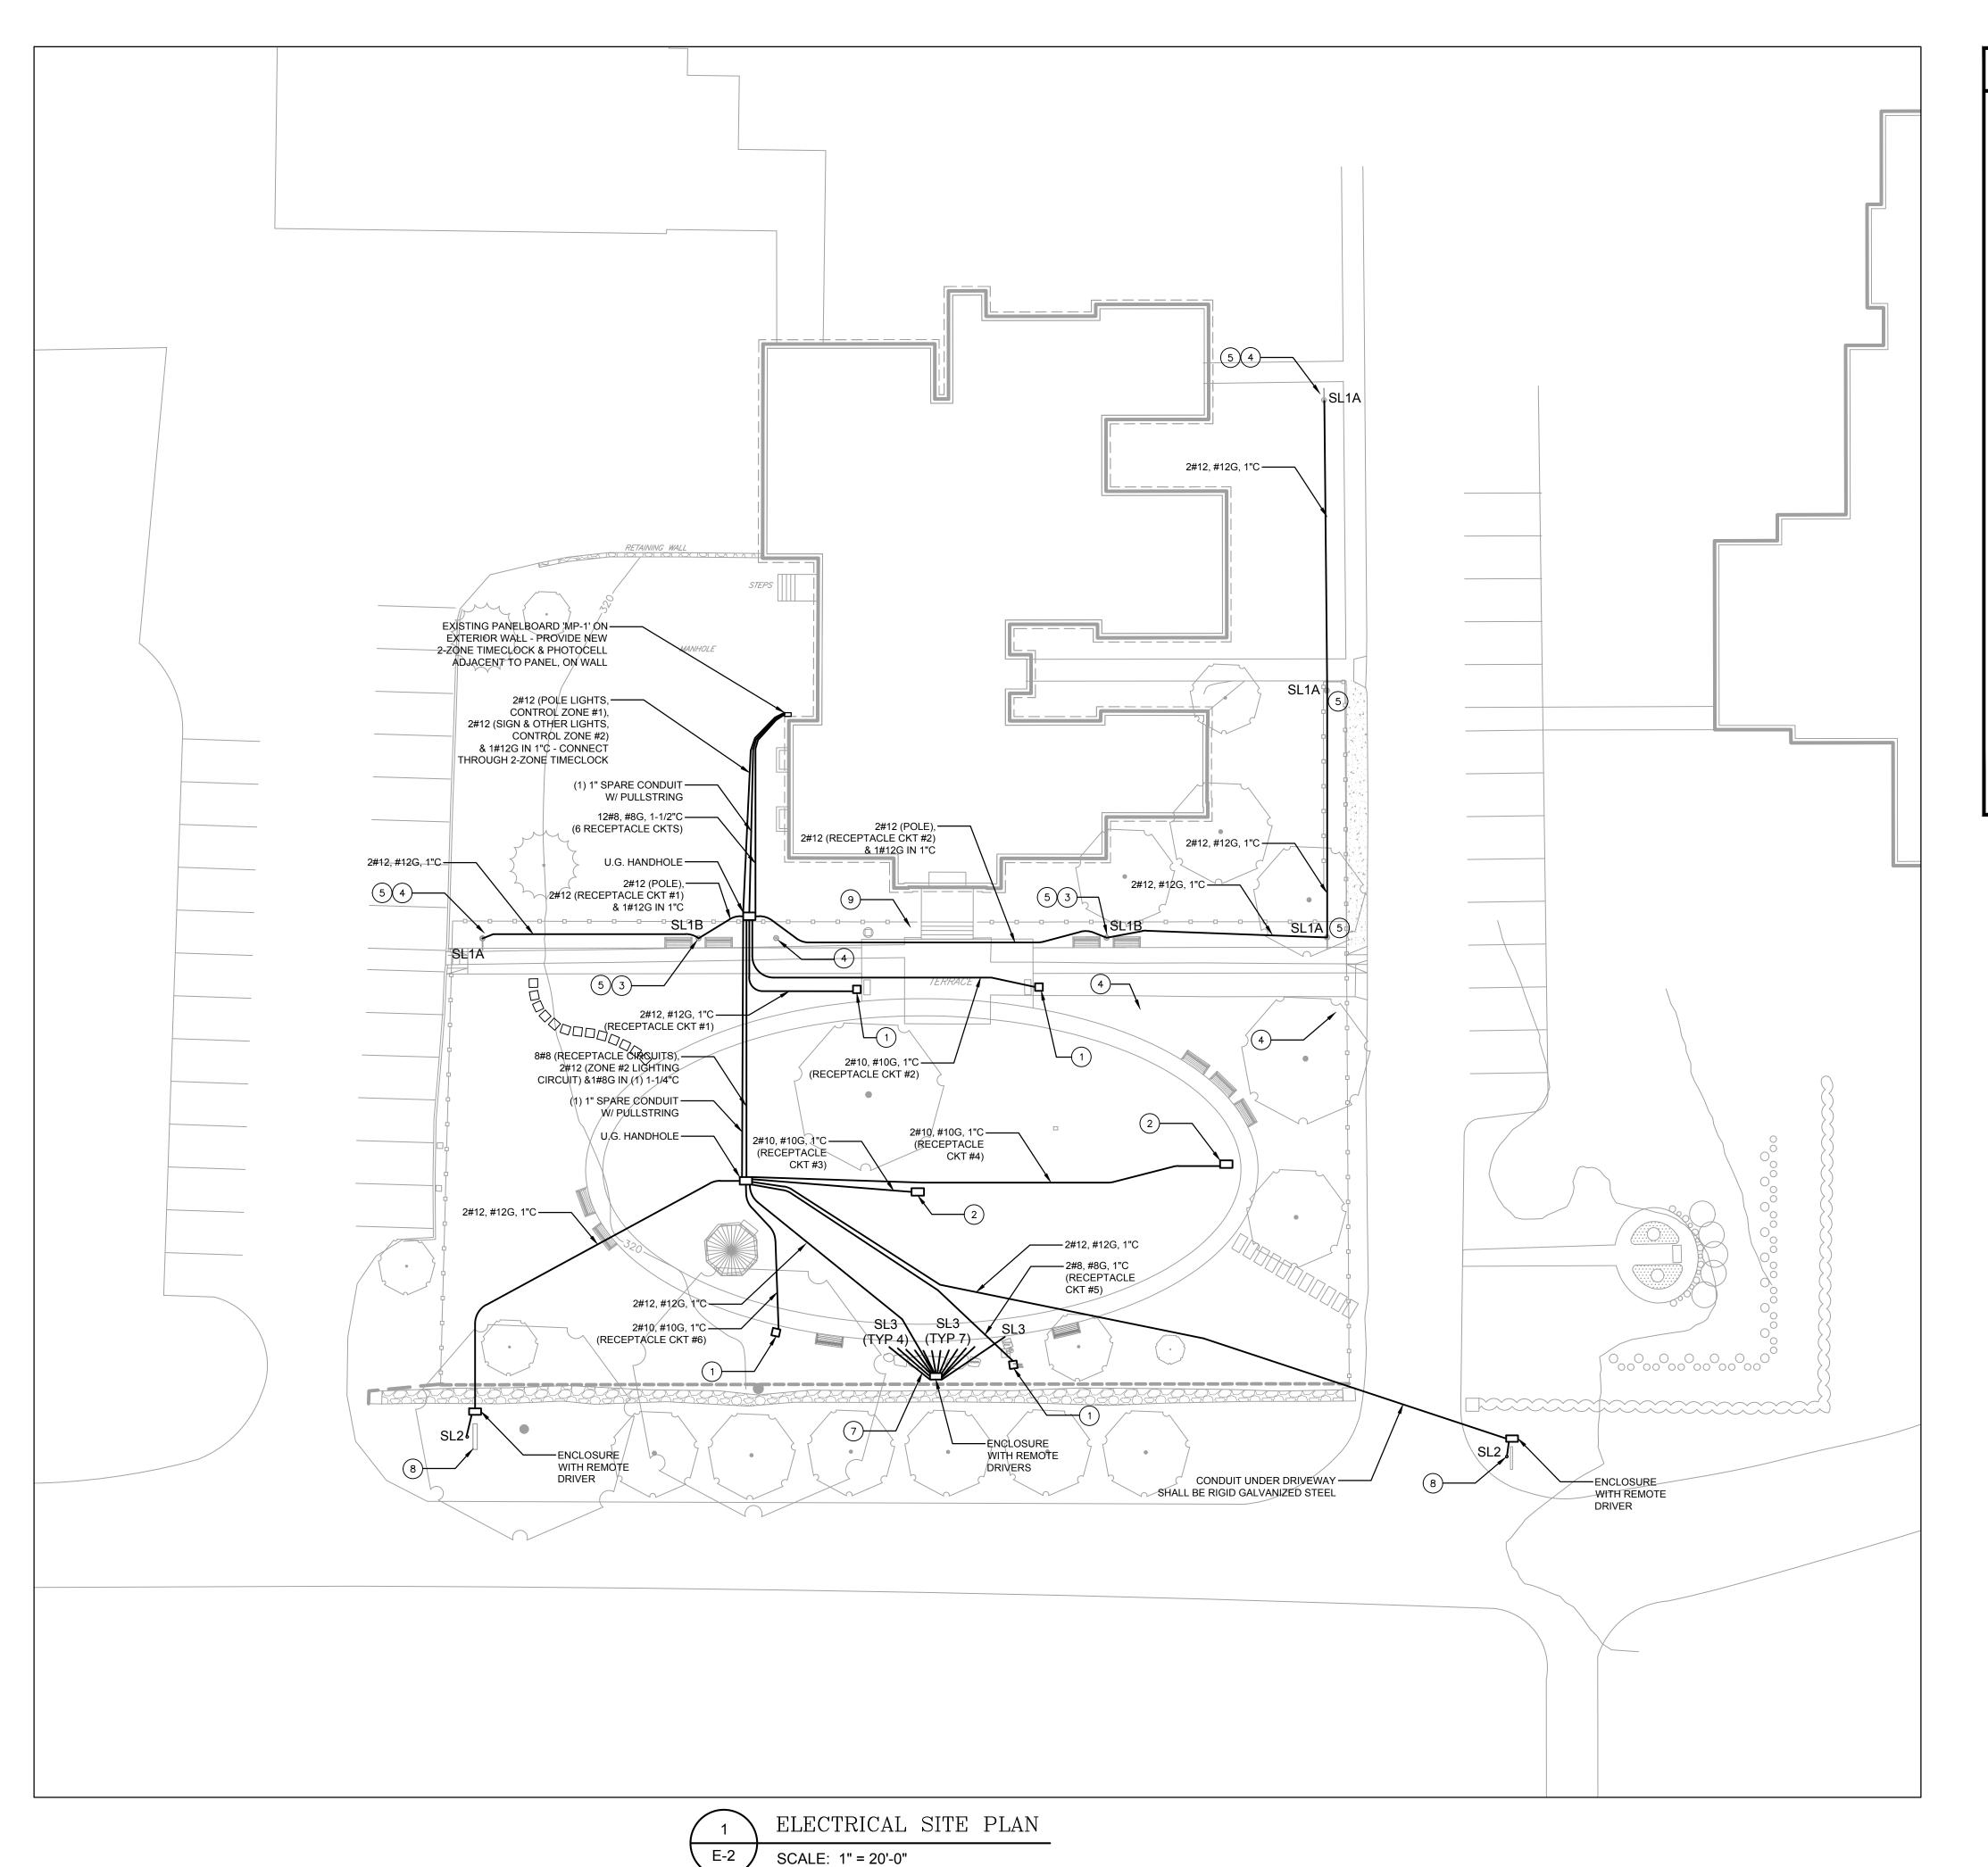

NEW WORK KEY NOTES

- 1. PROVIDE A 16"H OUTDOOR POWER PEDESTAL (LEGRAND XPP2G16C OR EQUAL) WITH LOCKABLE IN-USE COVER & TWO WEATHER RESISTANT USB GFCI DUPLEX RECEPTACLES IN THIS LOCATION. FEED FROM A NEW 20A-1P BREAKER IN EXISTING PANEL 'MP-1'. LANDSCAPE ARCHITECT TO SELECT COLOR. CONFIRM FINAL LOCATION OF PEDESTAL WITH TOWN OF WESTON PRIOR TO INSTALLATION.
- 2. PROVIDE A GFCI QUADRUPLEX RECEPTACLE IN FLUSH MOUNTED WEATHERPROOF GROUND BOX IN THIS LOCATION. GROUND BOX SHALL BE LEGRAND 'XB' SERIES OR EQUAL. FEED FROM A NEW DEDICATED 20A-1P BREAKER IN THE EXISTING PANEL. LANDSCAPE ARCHITECT TO SELECT FINISH. CONFIRM FINAL LOCATION OF BOX WITH TOWN OF WESTON PRIOR TO INSTALLATION
- 3. MOUNT A GFCI WEATHERPROOF DUPLEX RECEPTACLE TO THE LIGHT POLE IN THIS LOCATION. RECEPTACLE SHALL NOT BE FED FROM THE SAME CIRCUIT AS THE LIGHT FIXTURE, SO THAT IT REMAINS ENERGIZED REGARDLESS OF TIMECLOCK CONTROL. CONNECT TO CIRCUIT # INDICATED.
- 4. REMOVE EXISTING LIGHT POLE IN THIS LOCATION, INCLUDING ASSOCIATED WIRING AND RACEWAYS BACK TO SOURCE. EXISTING UNDERGROUND RACEWAYS MAY BE ABANDONED IN PLACE IF REMOVAL IS NOT FEASIBLE. SALVAGE EXISTING FIXTURE ON TOP OF POLE FOR RE-USE. OWNER WILL RETROFIT EXISTING FIXTURES WITH LED LAMP SOURCE AND HAND OVER TO CONTRACTOR FOR INSTALLATION ONTO NEW POLES.
- 5. PROVIDE A NEW LIGHT POLE IN THIS LOCATION, INCLUDING ASSOCIATED WIRING, RACEWAYS & STRUCTURAL FOUNDATION. INSTALL RETROFITTED LED FIXTURE (FURNISHED BY OWNER) ON NEW POLE. REFER TO DRAWING E-1 FOR LIGHTING FIXTURE SCHEDULE. ALL POLE LIGHTS SHALL BE FED FROM TIMECLOCK CONTROL ZONE #1.
- 6. NOT USED.
- 7. PROVIDE NEW IN-GRADE LIGHTING FIXTURES (QTY=12) FOR MEMORIALS, INCLUDING ASSOCIATED WIRING, RACEWAYS, ENCLOSURE, REMOTE DRIVERS & MOUNTING ACCESSORIES. REFER TO DRAWING E-1 FOR LIGHTING FIXTURE SCHEDULE. MEMORIAL LIGHTS SHALL BE FED FROM TIMECLOCK CONTROL ZONE #2. PROVIDE UNDERGROUND WIRING FROM EACH FIXTURE TO REMOTE DRIVERS. REFER TO WK ASSOCIATES DRAWINGS FOR EXACT LOCATIONS OF FIXTURES
- 8. PROVIDE NEW IN-GRADE SIGN LIGHT(S) IN THIS LOCATION, INCLUDING ASSOCIATED WIRING, RACEWAYS, ENCLOSURE, REMOTE DRIVER & MOUNTING ACCESSORIES. REFER TO DRAWING E-1 FOR LIGHTING FIXTURE SCHEDULE. SIGN LIGHT(S) SHALL BE FED FROM TIMECLOCK CONTROL ZONE #2. PROVIDE UNDERGROUND WIRING FROM FIXTURE TO REMOTE DRIVER. REFER TO WK ASSOCIATES DRAWINGS FOR REQUIRED DISTANCE BETWEEN FIXTURE AND SIGN
- 9. EXISTING LIGHT POLE IN THIS LOCATION IS TO REMAIN. OWNER WILL RETROFIT EXISTING FIXTURE WITH LED LAMP SOURCE AND HAND OVER FOR USE ON NEW POLES. INSTALL RETROFITTED FIXTURE ON NEW POLE.

WILLIAM KENNY ASSOCIATES

LANDSCAPE ARCHITECTURE • ECOLOGICAL SERVICES

1899 Bronson Road Fairfield CT 06824 203 366 0588 www.wkassociates.net

PROJECT:

WESTON TOWN GREEN

OWNER / CLIENT:

WESTON BEAUTIFICATION COMMITTEE

56 NORFIELD ROAD WESTON, CT

ELECTRICAL ENGINEER:



56 FOXCROFT COURT SOUTHINGTON, CT

PROGRESS ISSUE:

1 ISSUED FOR BID

02/10/2023

KEY PLAN:

SCALE: |0' |10' |20'

SEAL



SHEET TITLE:

SITE ELECTRICAL PLAN

SHEET NUMBER:

E-2